
GENERAL NOTES:

- 1. THE WORKS SHALL BE CONSTRUCTED IN ACCORDANCE WITH THE CURRENT COUNCIL/MPA/VICROADS/MELBOURNE WATER STANDARD DRAWINGS AND SPECIFICATIONS. WORKS TO BE CARRIED OUT TO THE SATISFACTION OF COUNCIL'S SUPERVISING OFFICER.
- 2. THE CONTRACTOR IS RESPONSIBLE FOR SAFETY OF WORK ON SITE IN ACCORDANCE WITH APPROPRIATE LEGISLATION. HE/SHE SHALL ERECT AND MAINTAIN ALL SHORING, PLANKING AND STRUTTING, DEWATERING DEVICES, BARRICADES, SIGNS, LIGHTS, ETC. NECESSARY TO KEEP WORKS IN A SAFE AND STABLE CONDITION, AND TO PROTECT THE PUBLIC FROM HAZARDS ASSOCIATED WITH THE WORKS.
- 3. THE CONTRACTOR SHALL:
- 3.1. COMPLY WITH THE SAFETY REQUIREMENTS OF THE MINES ACT, GENERAL REGULATIONS AND STATUTORY RULES, AND THE MINES (TRENCHES) REGULATIONS 1982.
- NOTIFY THE OCCUPATIONAL HEALTH AND SAFETY AUTHORITY OF HIS INTENTION TO COMMENCE TRENCHING OPERATIONS WHERE TRENCHES ARE 1.5 METERS OR DEEPER.
- ENSURE THAT THE MINE MANAGER OR HIS DEPUTY AS REQUIRED BY THE REGULATIONS IS IN ATTENDANCE WHEN TRENCHING OPERATIONS ARE IN PROGRESS.
- OBTAIN A ROAD OPENING PERMIT FOR ANY WORKS WITHIN EXISTING ROAD RESERVES OR ANY WORKS ON EXISTING INFRASTRUCTURE.
- 4. THE CONTRACTOR SHALL NOTIFY COUNCIL'S SURVEILLANCE CO-ORDINATOR AND ALL SERVICE AUTHORITIES SEVEN (7) DAYS PRIOR TO COMMENCEMENT OF CONSTRUCTION.
- 5. THE LOCATION OF EXISTING SERVICES SHALL BE DETERMINED BY THE CONTRACTOR PRIOR TO COMMENCING ANY EXCAVATION BY CONTACTING ALL RELEVANT SERVICE AUTHORITIES. ANY EXISTING SERVICES SHOWN ON THE DRAWINGS ARE OFFERED AS A GUIDE ONLY AND ARE NOT GUARANTEED AS CORRECT.
- 6. ALL ROAD CHAINAGES ARE MEASURED ALONG THE ROAD CENTRELINE EXCEPT KERB RETURNS AND COURTHEADS, WHERE LIP OF KERB CHAINAGES ARE SPECIFIED. ALL DIMENSIONS AND RADII ARE GIVEN TO THE LIP OF KERB UNLESS NOTED OTHERWISE. DO NOT SCALE OFF THESE DRAWINGS, WRITTEN DIMENSIONS ONLY SHALL BE USED.
- 7. CONDUIT LOCATIONS ARE SUBJECT TO AMENDMENT AND CONDUITS SHALL NOT BE LAID UNTIL WRITTEN APPROVAL IS GIVEN BY THE SUPERINTENDENT. BOTH KERBS ARE TO BE MARKED WITH THE LETTERS G,W AND T ABOVE CONDUIT LOCATIONS AS SPECIFIED. CONDUITS TO BE PLACED MINIMUM OF 5m FROM BOUNDARIES WHERE POSSIBLE AND TO THE SATISFACTION OF THE SUPERINTENDENT IN ACCORDANCE WITH COUNCIL STANDARD DRAWINGS.
- 8. SUBSOIL DRAINS SHALL BE INSTALLED BEHIND ALL KERB AND CHANNEL AS PER COUNCIL SPECIFICATION AND STANDARD DRAWINGS.
- 9. ALL LEVELS ARE TO AUSTRALIAN HEIGHT DATUM.
- 10. ALL EXCAVATED OR FILLED AREAS OUTSIDE THE ROAD RESERVES SHALL BE SURFACED WITH A 100mm LAYER OF TOPSOIL AS SPECIFIED. ALL FILLING ON ALLOTMENTS TO BE COMPACTED TO 95% STANDARD COMPACTION IN 150mm LAYERS AND AS PER THE SPECIFICATION. WHERE THERE IS FILL IN EXCESS OF 300mm IN DEPTH, THE CONTRACTOR IS TO CARRY OUT SOIL TESTS TO THE REQUIREMENTS OF APPENDIX B AS SPECIFIED IN THE CURRENT AUSTRALIAN STANDARD AS 3798 TO SHOW THAT LEVEL 1 COMPACTION STANDARDS HAVE BEEN ACHIEVED. TEST RESULTS AND LOCATION OF TESTS FOR EACH ALLOTMENT SHALL BE APPROVED BY THE CONTRACTOR AND SUBMITTED TO COUNCIL.
- 11. FILL MATERIAL USED UNDER PAVEMENTS AND FOOTPATHS MUST BE AN APPROVED MATERIAL IN ACCORDANCE WITH COUNCIL SPECIFICATION. ALL SUCH MATERIAL SHALL BE COMPACTED AS PER THE REQUIREMENTS OF THE SPECIFICATION APPROVED WITH THESE DRAWINGS PRIOR TO FORMWORK BEING PLACED. COMPACTION TESTS SHALL BE COMPLETED AND PROVIDED TO SUPERINTENDENT.
- 12. FILL & CUT BATTERS ARE NOT TO EXCEED 1 in 6 SLOPE, UNLESS SHOWN OTHERWISE.
- 13. ALL ALLOTMENTS SHALL BE SMOOTHED, GRADED AND SHAPED TO AN EVEN SURFACE BETWEEN FINISHED LEVELS SHOWN UNLESS NOTED OTHERWISE.
- 14. ALL STORMWATER DRAINAGE PIPES SHALL BE CLASS 2 RCP WITH SPIGOT AND SOCKET TYPE RUBBER RING JOINTS UNLESS NOTED OTHERWISE.
- 15. DRAINAGE PITS SHALL BE CAST MONOLITHICALLY, CEMENT RENDER SHALL ONLY BE USED TO REPAIR DEFECTS.
- 16. BACKFILLING OF TRENCHES WHERE DRAINAGE AND SEWERAGE ARE IN CLOSE PROXIMITY SHALL CONFORM TO COUNCIL STANDARD DRAWING MCC 704.
- 17. ALL SERVICING TRENCHES UNDER ROADS, FOOTPATHS, DRIVEWAYS, PARKING BAYS ETC. SHALL TO BE BACKFILLED WITH CLASS 2
- 18. ALL HOUSE DRAIN CONNECTIONS ARE TO BE LOCATED NO CLOSER THAN 5.00m FROM THE SIDE BOUNDARY UNLESS NOTED OTHERWISE.
- 19. INVERT OF PROPERTY INLETS SHALL TO BE 500mm MINIMUM BELOW FINISHED SURFACE UNLESS NOTED OTHERWISE.
- 20. VEHICLE CROSSINGS ARE TO BE LOCATED 0.75m FROM SIDE BOUNDARY OR EASEMENT UNLESS OTHERWISE SHOWN.
- 21. ADDITIONAL AND OVER-EXCAVATION SHALL BE BACKFILLED IN ACCORDANCE WITH THE PROVISIONS OF THE SPECIFICATION.
- 22. FOOTPATH CROSSFALL SHALL BE 1:50 UNLESS NOTED OTHERWISE.
- 23. TREES AND SHRUBS SHALL BE RETAINED, UNLESS ROAD CONSTRUCTION NECESSITATES THEIR REMOVAL, REMOVAL IS DIRECTED BY SUPERINTENDENT.
- 24. TREES MARKED ON THE APPROVED PLANS FOR REMOVAL MUST BE REMOVED FROM THE SITE PRIOR TO THE COMMENCEMENT OF WORKS. NO EXCAVATION SHALL BE CARRIED OUT WITHIN 5.0m OF ANY EXISTING TREE UNTIL APPROVAL HAS BEEN GIVEN BY COUNCIL'S SUPERVISING OFFICER.
- 25. INSTALL BLUE RAISED REFLECTIVE PAVEMENT MARKER (BRRPM) ON ROAD CENTRELINE AND "GROUND BALL" MARKER POST TO INDICATE LOCATION OF FIREPLUG.
- 26. ALL LINEMARKING, SIGNAGE AND TRAFFIC CONTROL DEVICES SHALL ACCORD WITH AS1742 "MANUAL OF UNIFORM TRAFFIC CONTROL DEVICES."
- 27. THE CONTRACTOR IS TO ENSURE THAT THEIR CONSTRUCTION PROCEDURES AND STANDARDS CONTROL THE VOLUME AND LOCATION FOR COLLECTION OF SEDIMENT RUNOFF ACCORDING TO CURRENT EPA – ENVIRONMENTAL GUIDELINES FOR MAJOR CONSTRUCTION
- 28. UPON COMPLETION OF CONSTRUCTION THE WHOLE SITE SHALL BE CLEANED UP, GRADED AND ALL RUBBISH REMOVED. THE SITE IS TO BE LEFT IN A CLEAN AND TIDY CONDITION TO THE SATISFACTION OF THE SUPERINTENDENT.
- 29. EXISTING PAVEMENT OR DRAINAGE WORKS DAMAGED DURING CONSTRUCTION OR THE MAINTENANCE PERIOD TO BE REINSTATED TO THE SATISFACTION OF THE SUPERINTENDENT.
- 30. THE LOWER SUB-BASE QUALITY MATERIAL SHALL COMPRISE OF RIPPED ROCK IN ACCORDANCE WITH COUNCIL SPECIFICATIONS.

SERVICES CONTACTS

AUTHORITY	TELEPHONE
SP AUSNET	(03) 9396 7631
WESTERN WATER	1300 650 425
POWERCOR	132 206
TELSTRA	
MELTON SHIRE COUNCIL	(03) 9747 7200
	SP AUSNET WESTERN WATER POWERCOR TELSTRA

SHEET NO. | DRAWING TITLE GENERAL NOTES, LOCALITY PLAN & DRAWING INDEX 13R2 PAVEMENT COMPOSITION 13R3 LAYOUT PLAN - 1 13R4 LAYOUT PLAN - 2 ----- REMOVED 13R5 LAYOUT PLAN - 3 13R6 FUCHSIA DRIVE: LONGITUDINAL AND CROSS SECTIONS 13R7 INNOVATION AVENUE: LONGITUDINAL AND CROSS SECTIONS - 1 13R8 INNOVATION AVENUE: CROSS SECTIONS - 2 13R9 KERALA STREET: LONGITUDINAL AND CROSS SECTIONS 13R10 DELHI GROVE: LONGITUDINAL AND CROSS SECTIONS - 1 13R11 DELHI GROVE: CROSS SECTIONS - 2 13R12 SUNDAR PLACE: LONGITUDINAL AND CROSS SECTIONS PATEL PLACE: LONGITUDINAL AND CROSS SECTIONS 13R14 AUNTY LANE: LONGITUDINAL AND CROSS SECTIONS REMOVED 13R15 UNCLE LANE: LONGITUDINAL AND CROSS SECTIONS REMOVED INTERSECTION DETAILS AND KERB SETOUT - 1 13R16 13R17 INTERSECTION DETAILS AND KERB SETOUT - 2 13R18 INTERSECTION DETAILS AND KERB SETOUT - 3 13R19 INTERSECTION DETAILS AND KERB SETOUT - 4 TEMPORARILY EXCLUDED INTERSECTION DETAILS AND KERB SETOUT - 5 TEMPORARILY EXCLUDED 13R21 INTERSECTION DETAILS AND KERB SETOUT - 6 TEMPORARILY EXCLUDED 13R22 DRAINAGE LONG SECTIONS 1 REMOVED 13R23 DRAINAGE LONG SECTIONS - 2 13R24 DRAINAGE LONG SECTIONS - 3 DRAINAGE LONG SECTIONS - 4 13R25 13R26 DRAINAGE LONG SECTIONS - 5 13R27 DRAINAGE LONG SECTIONS - 6 AND PIT SCHEDULE 13R28 SIGNAGE & LINEMARKING PLAN - 1 13R29 SIGNAGE & LINEMARKING PLAN - 2 13R30 PLAN OF SUBDIVISION - 1 13R31 PLAN OF SUBDIVISION - 2 13R32 GRAVEL TRENCH (KERB INLET DIVERSION DETAILS) 13R33 PASSIVE IRRIGATION LAYOUT PLAN 13R34 AGRICUL TURAL DRAIN PLAN —— TEMPORARILY EXCLUDED 13R35 LANEWAY CONSTRUCTION JOINT DETAILS - 1 LANEWAY CONSTRUCTION JOINT DETAILS - 2

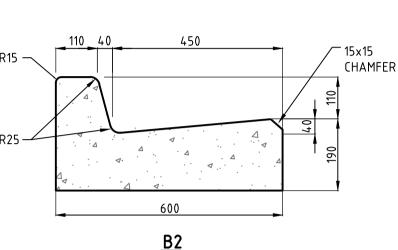

SERVICES SCHEDULE							
STREET NAME	GAS	D-WATER	TELSTRA	ELECT.	SEWER	TREES BOTH SIDES	ROAD RESERVE
FUCHSIA DRIVE	2.10 S	2.60 S	2.35 N	2.90 N	N/A	0.80 B.O.K.	20.00
INNOVATION AVENUE	2.10 E	2.75 E	1.85 W	2.60 W	1.00 E & 1.00 W	0.80 B.O.K.	25.50
KERALA STREET	2.10 N	2.60 N	1.775 S	2.40 S	1.00 N	0.80 B.O.K.	16.00
DELHI GROVE	2.10 W	2.60 W	1.775 E	2.40 E	1.00 E & 1.00 W	0.80 B.O.K.	16.00
DELHI GROVE (LOT 1385 TO 1391)	2.30 N	2.75 N	1.775 N	3.90 N	N/A	0.80 B.O.K.	14.00
SUNDAR PLACE	2.35 N	2.90 N	1.825 N	3.90 N	EX. 1.00 N	0.80 B.O.K.	14.10
PATEL PLACE	2.35 N	2.90 N	1.825 N	3.90 N	EX. 1.00 N	0.80 B.O.K.	14.10


× DENOTES EXISTING SERVICE EXACT LOCATION TO BE PROVEN ON SITE BY CONTRACTOR.

ALL OFFSETS ARE REFERENCED TO NEAREST BL.

ROAD SCHEDULE				
STREET NAME	STREET NAME ROAD RESERVE		FOOTPATH WIDTH AND SIDE	CLASSIFICATION
FUCHSIA DRIVE	FUCHSIA DRIVE 20.00		2.00 N / 1.50 S	ACCESS STREET LEVEL 2
INNOVATION AVENUE	25.50	11.20	1.50 E / 1.50 W	CONNECTOR STREET
KERALA STREET	16.00	7.30	1.50 N / 1.50 S	ACCESS STREET LEVEL 1
DELHI GROVE	16.00	7.30	1.50 E / 1.50 W	ACCESS STREET LEVEL 1
DELHI GROVE (LOT 1385 TO 1391)	14.00	5.50	1.50 N	ACCESS PLACE
SUNDAR PLACE	14.10	5.50	1.50 N	LANE WAY
PATEL PLACE	14.10	5.50	1.50 N	LANE WAY

ADDITIONAL NOTE:

A CCTV INSPECTION OF ALL DRAINAGE HOUSE CONNECTIONS IS TO BE UNDERTAKEN BY THE CONTRACTOR TO THE SATISFACTION OF COUNCIL'S WORK SUPERVISOR.

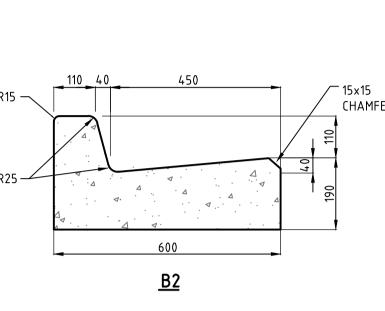

urdefhist it Mai havongs	Ent Sundowner Rockbank Caravan Park Fire Stn State Rec Rec Rec Rec Rec Res Solchank	
	RD	SITE OF WORKS

LOCALITY PLAN NOT TO SCALE

COORDINATE DATUM: SITE MGA 94 ZONE 55 VIDE MELBpos LEVEL DATUM: AHD VIDE PM 12 (PARISH OF KOROROIT) R.L 105.966 (SMES 4 SEP,2012)

CONTOUR INTERVAL: 0.5m GRID INTERVAL: 250m

Temporary/Permanent Bench Marks

No.	Easting	Northing	R.L.	Description
1	294062.93	5820269.25	102.7	C208RVTKT
2	294066.36	5820228.92	103.07	C207SSPT
3	294210.6	5820007.19	102.68	C10SSPG

AS-CONSTRUCTED PLAN

THIS PLAN HAS BEEN PREPARED TO REFLECT THE WORKS AS PRESENTED AT END OF SUBDIVISION CONSTRUCTION. THE PLAN IS NOT BASED ON SURVEY OF THE COMPLETED WORKS. ALL LEVELS, CO-ORDINATES AND SERVICE LOCATIONS SHOWN ON THE PLANS ARE THE DESIGN INFORMATION AND SHOULD NOT BE RELIED UPON BY ANY FUTURE PARTY IN RELATION TO DETAILED DESIGN ACTIVITIES. THESE PLANS ARE PROVIDED TO COUNCIL FOR ASSET MANAGEMENT PURPOSES AND ANY USE OF THE PLANS BY THIRD PARTIES IS NOT PERMITTED. ANY SUBSEQUENT DESIGN OR CONSTRUCTION ACTIVITIES IN THE AREA DEFINED ON THESE PLANS WILL REQUIRE ADDITIONAL SITE SURVEY AND **ASSET PROVING BY THE RELEVANT PARTY.**

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> 1				
AU\UW	F	AS CONSTRUCTED	21.06.23	JZ
13 \LA	E	SERVICES SCHEDULE AMENDED	19.08.22	JZ
20	D	INTERSECTION EXCLUDED FROM CURRENT WORKS	28.02.22	JZ
15 A	С	CONSTRUCTION ISSUE	18.01.22	JZ
\2225	В	LOT LAYOUT AMENDED	06.08.21	JZ
/7	VERSION	REMARKS		

DRAWN BY	N. KASHA	DESIGNED BY	J. ZHOU	
MELWAY	344, K12	CHECKED BY	L. PHAN	
DATUM	AHD	AUTHORISED BY	S. RAVIDA	





CITY OF MELTON BRIDGEFIELD ESTATE, ROCKBANK STAGE 13 GENERAL NOTES, LOCALITY PLAN


& DRAWING INDEX

REFERENCE 22236E/13

DRAWING No.

1 OF 36

VERSION

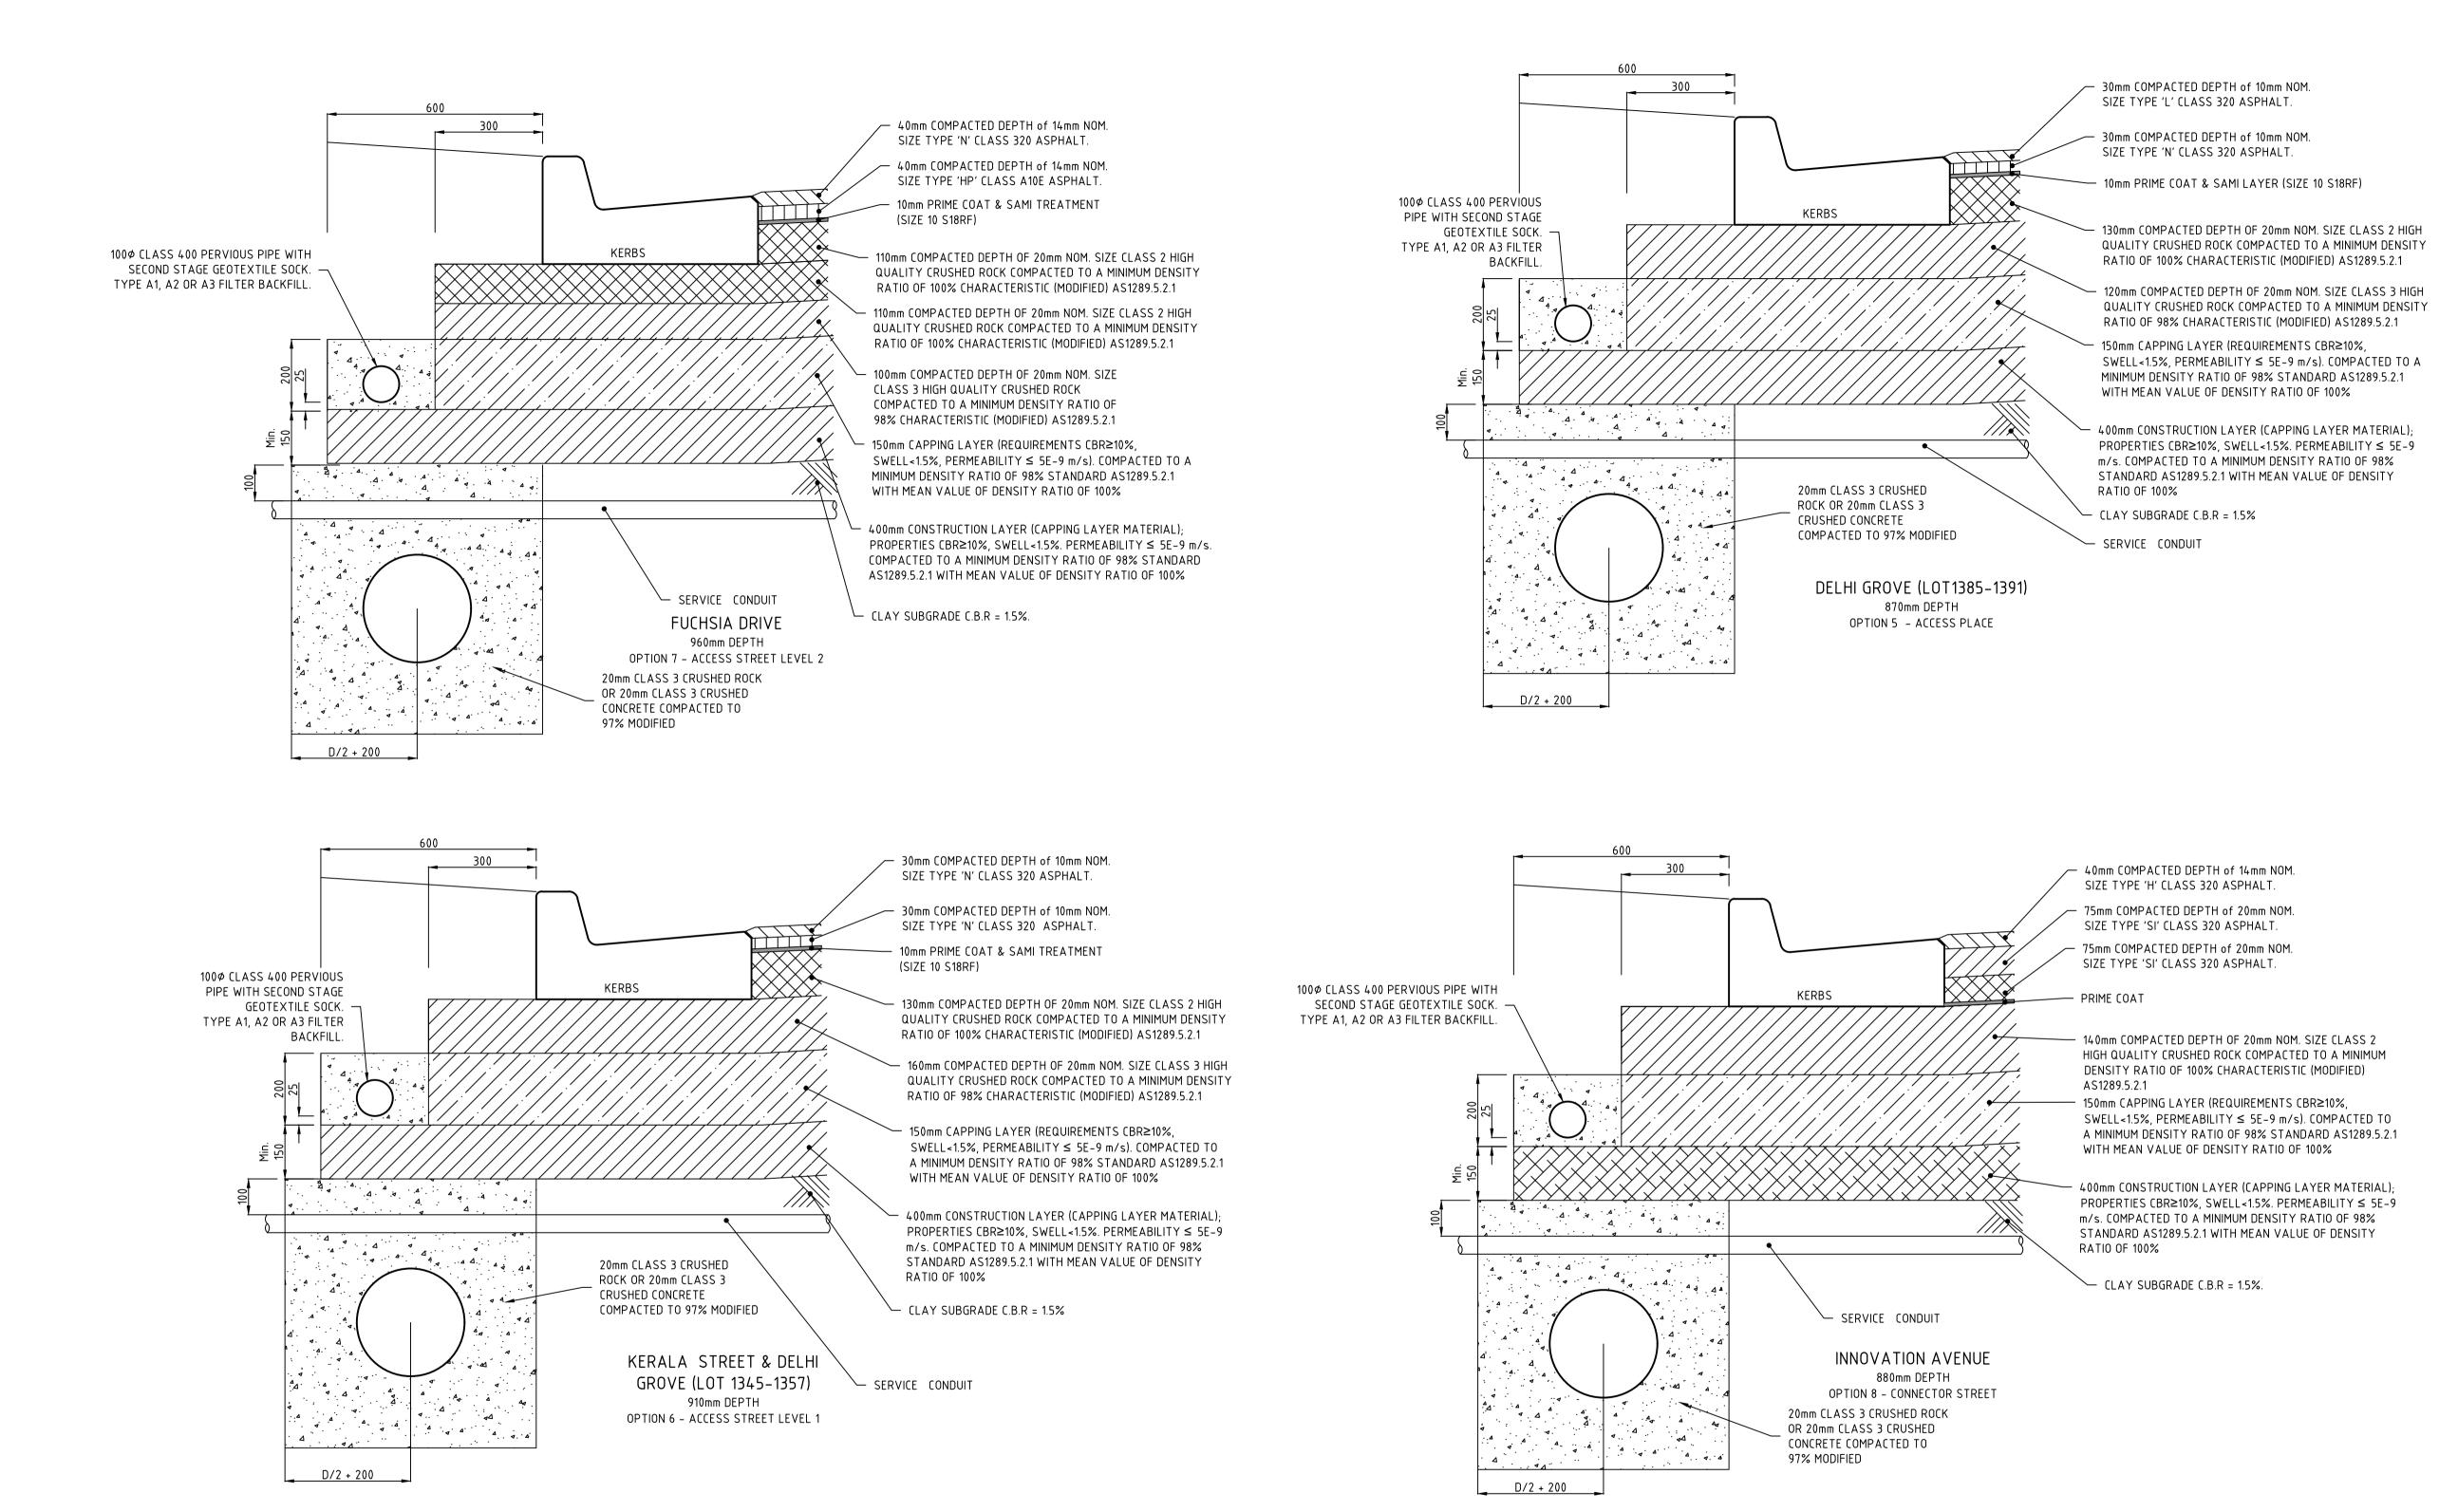

PAVEMENT NOTES

- REFER TO "GEOTECHNICAL INVESTIGATION & PAVEMENT DESIGN" REPORT R7591-1-R3 DATED 8th FEBRUARY 2022 SITE GEOTECHNICAL Pty Ltd FOR COMPLETE PAVEMENTS DESIGN.
- PAVEMENT DEPTHS SHALL BE MODIFIED IF DIRECTED BY THE SUPERINTENDENT.
- ANY CHANGE TO THE ABOVE PAVEMENTS SHALL BE APPROVED IN WRITING

- BY COUNCIL'S SUPERINTENDENT. • INSPECTION AND TESTING OF PAVEMENTS SHALL BE CARRIED OUT TO
- COUNCIL SPECIFICATIONS
- DEPTHS SHOWN ARE CONSOLIDATED THICKNESSES IN MILLIMETRES.

AS-CONSTRUCTED PLAN

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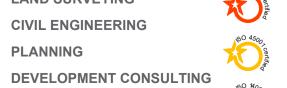
	Н	AS CONSTRUCTED	21.06.23	JZ
3/CA	G	PAVEMENT AMENDED	31.03.22	JZ
GE 1	F	PAVEMENT AMENDED	28.02.22	JZ
\STA	E	PAVEMENT AMENDED	18.02.22	JZ
2236	D	CONSTRUCTION ISSUE	18.01.22	JZ
1.\2;	VERSION	REMARKS		

DRAWN BY	N. KASHA	DESIGNED BY	J. ZHOU	
MELWAY	344, K12	CHECKED BY	L. PHAN	
DATUM	AHD	AUTHORISED BY	S. RAVIDA	



LAND SURVEYING **CIVIL ENGINEERING PLANNING**


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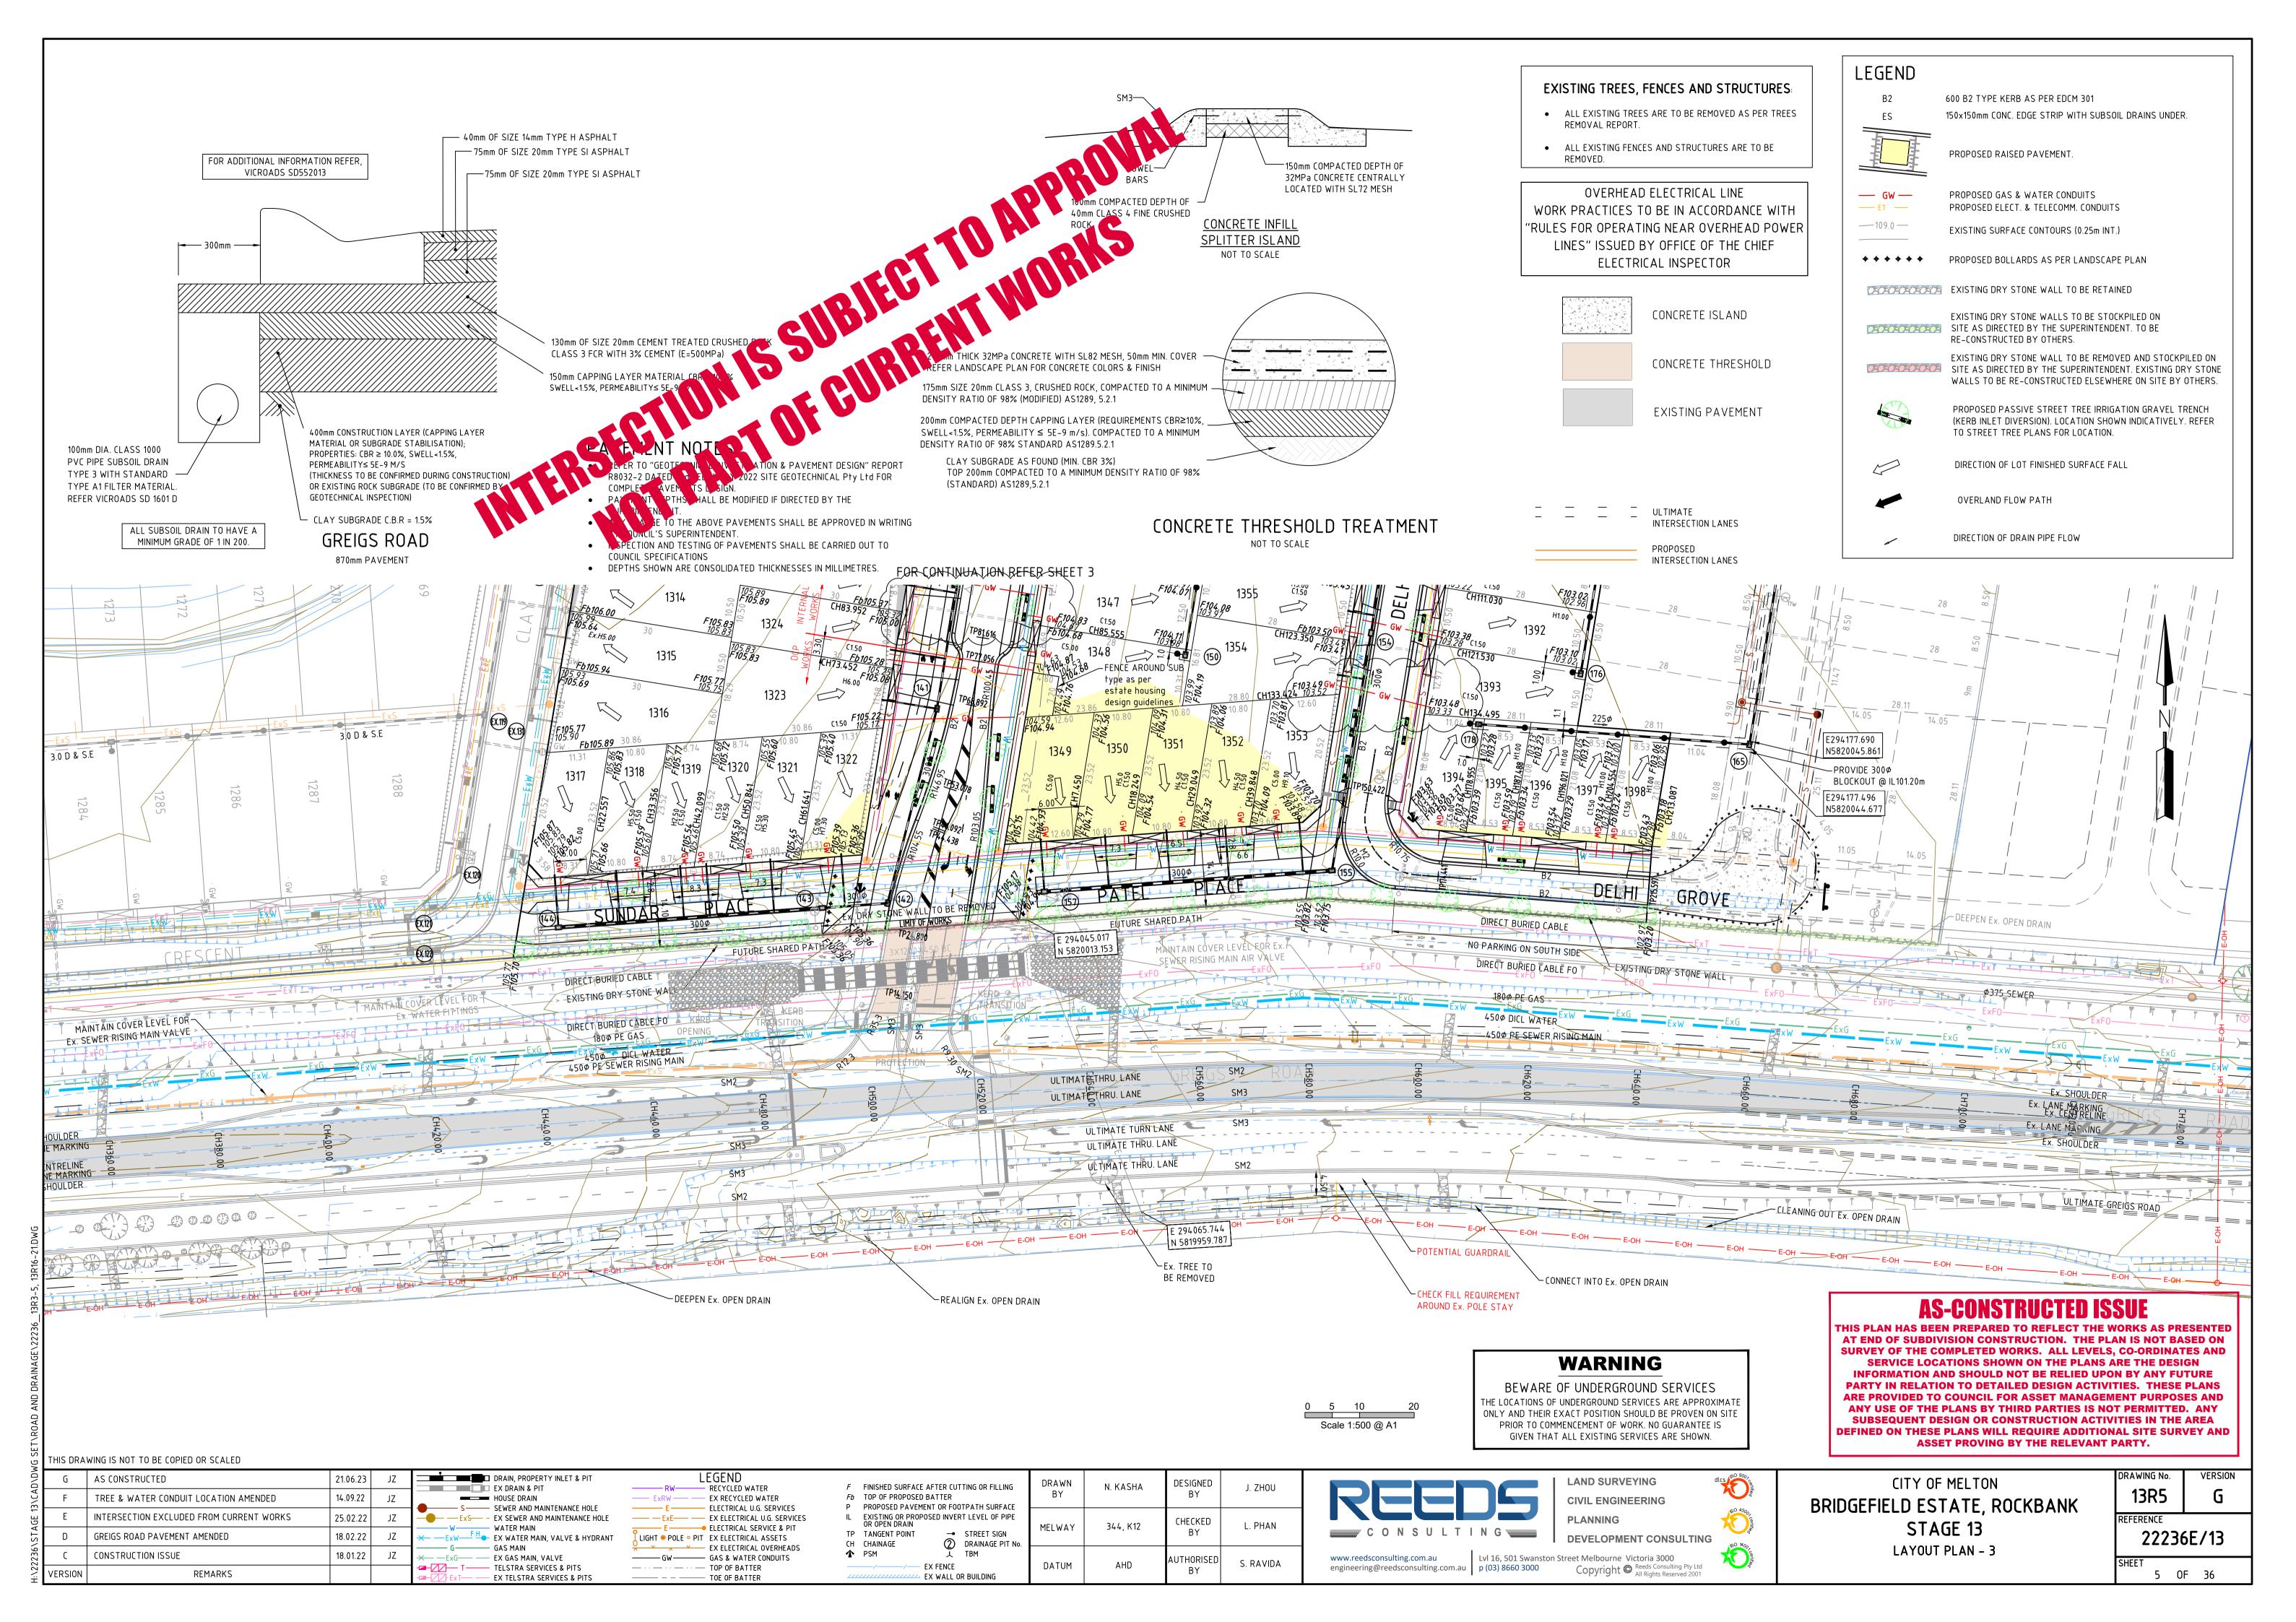


CITY OF MELTON BRIDGEFIELD ESTATE, ROCKBANK STAGE 13 PAVEMENT COMPOSITION


VERSION DRAWING No. 13R2 REFERENCE


22236E/13 SHEET




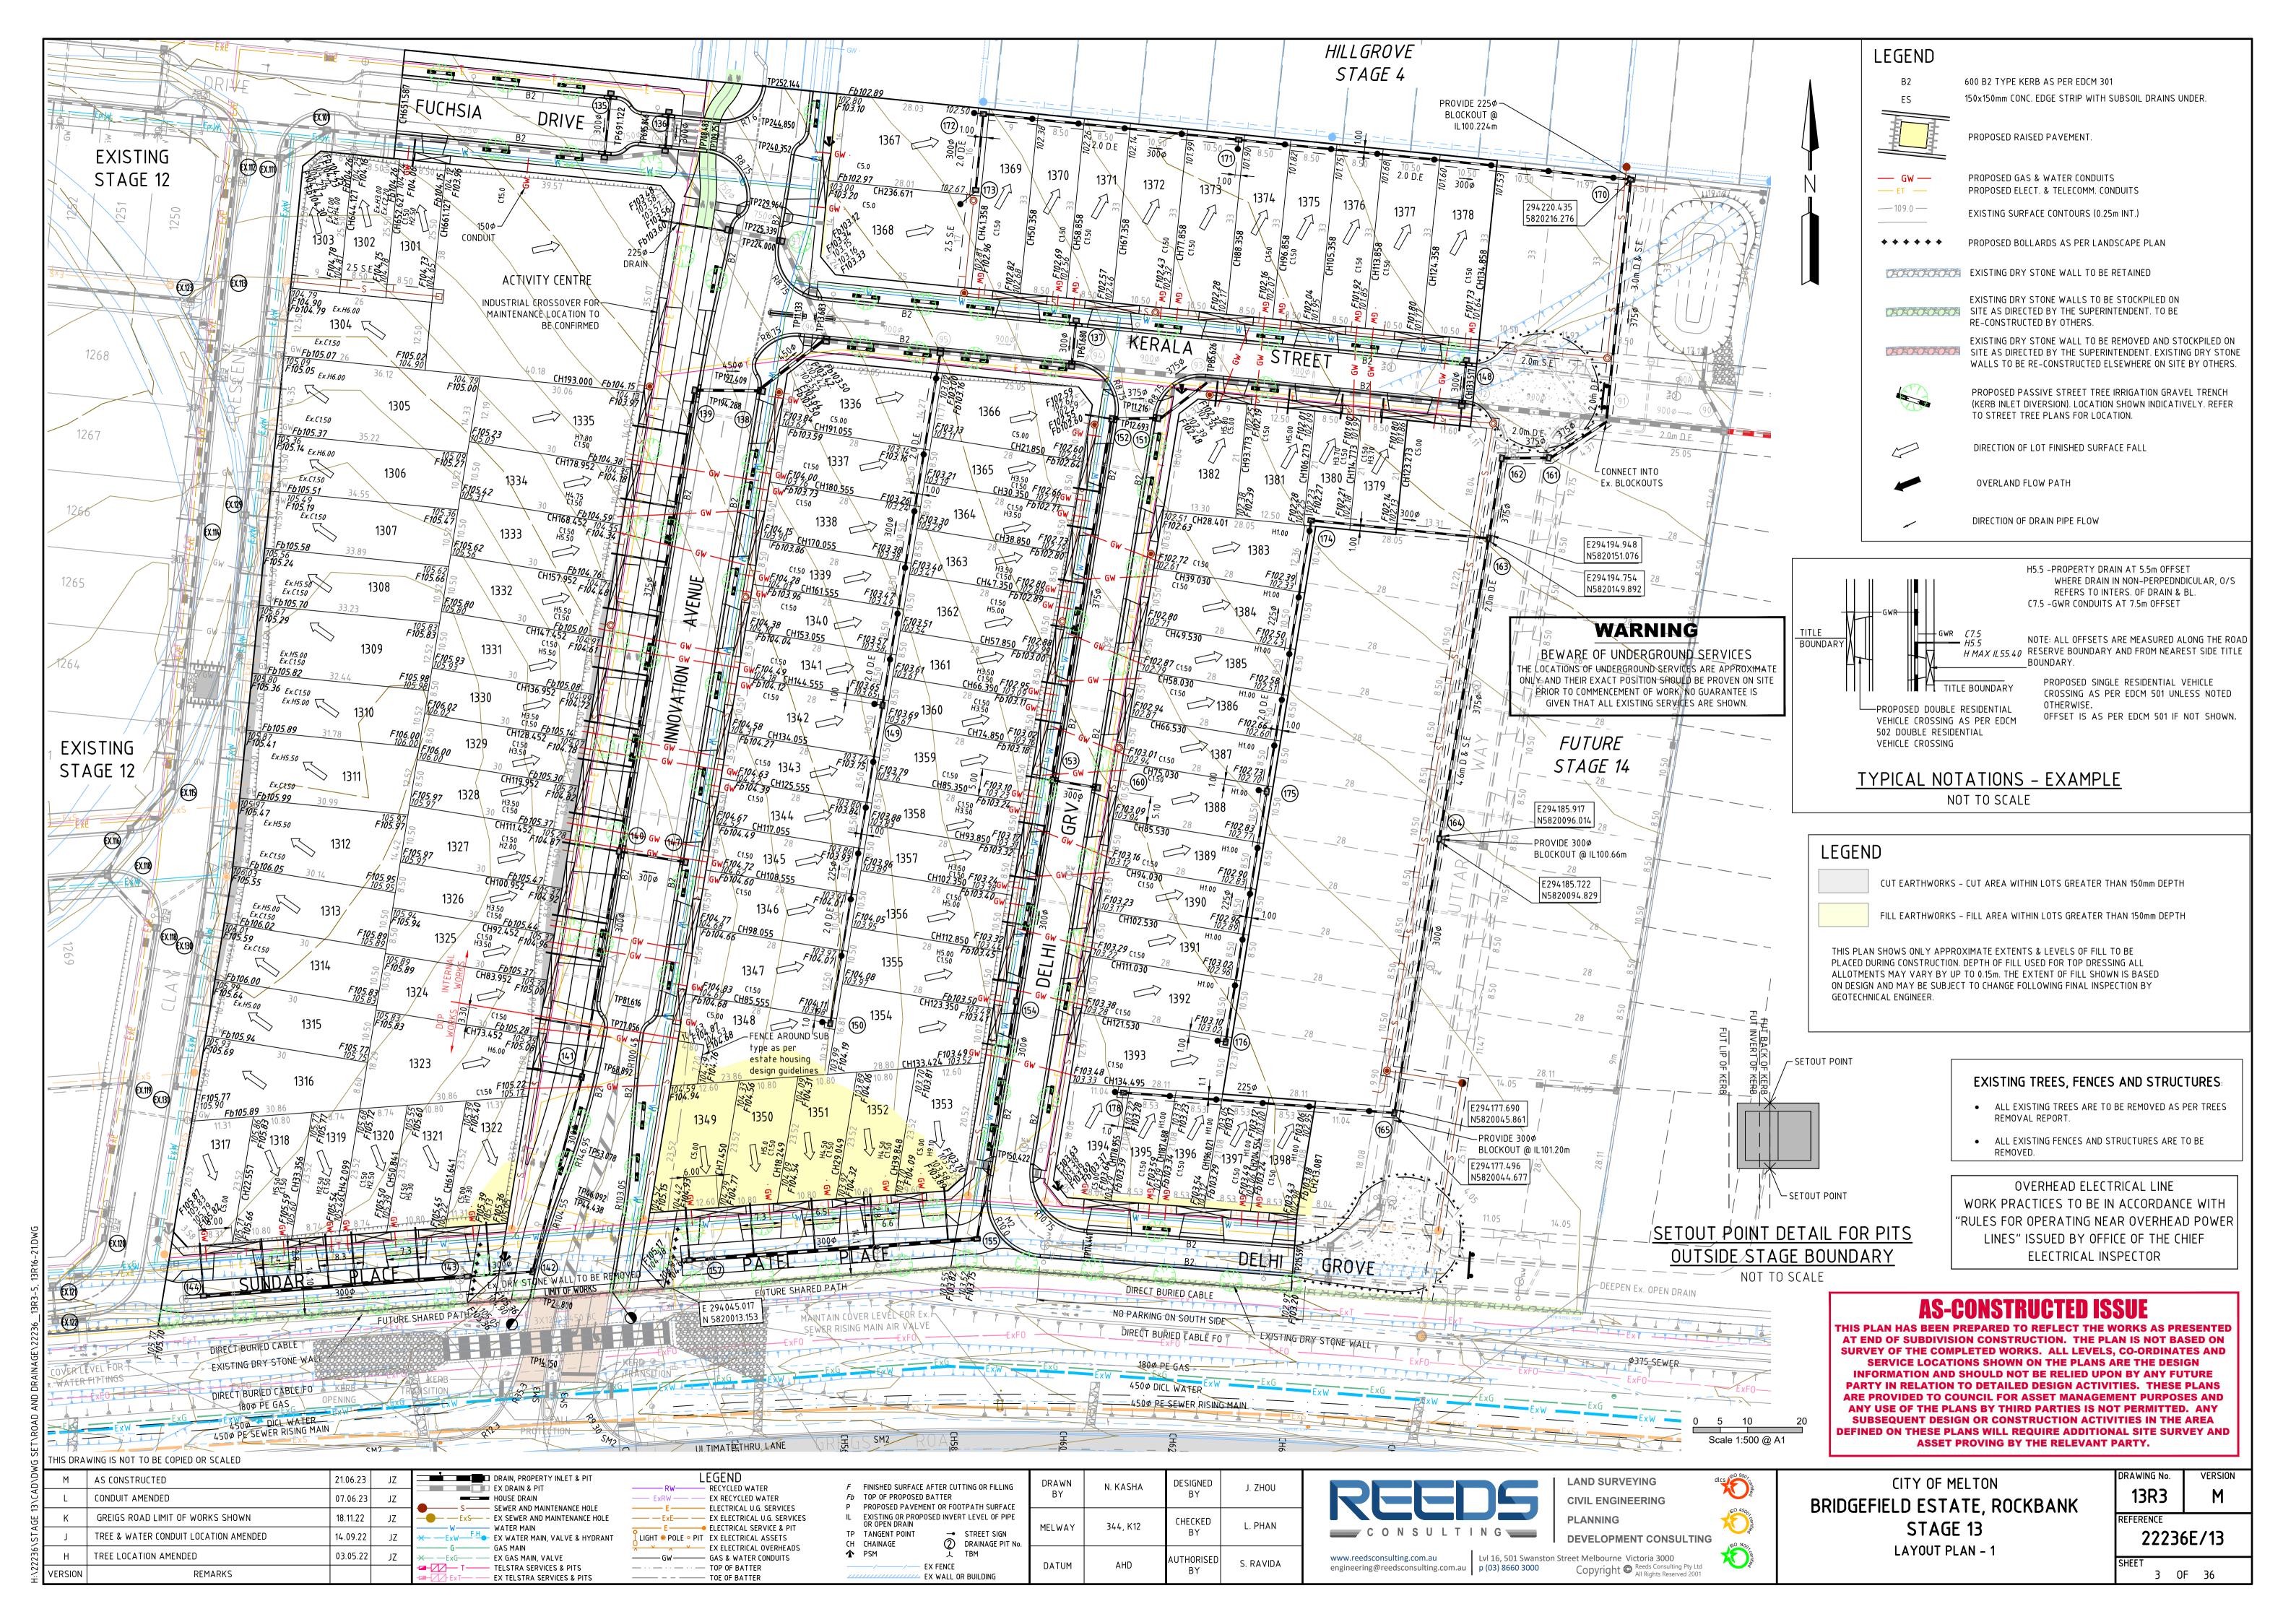



LONGITUDINAL SECTION FUCHSIA DRIVE

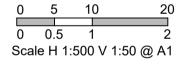

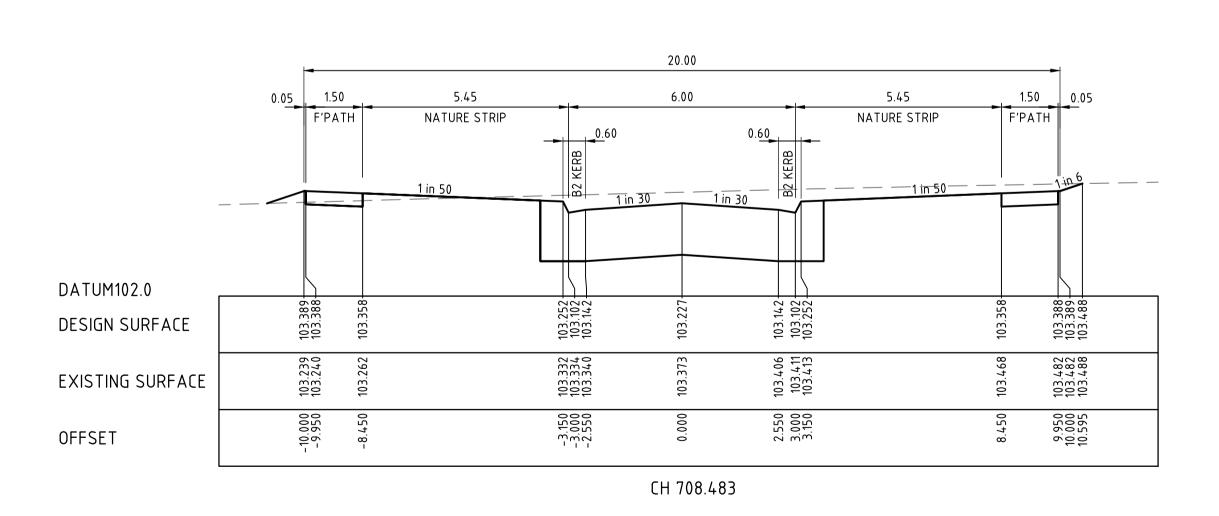


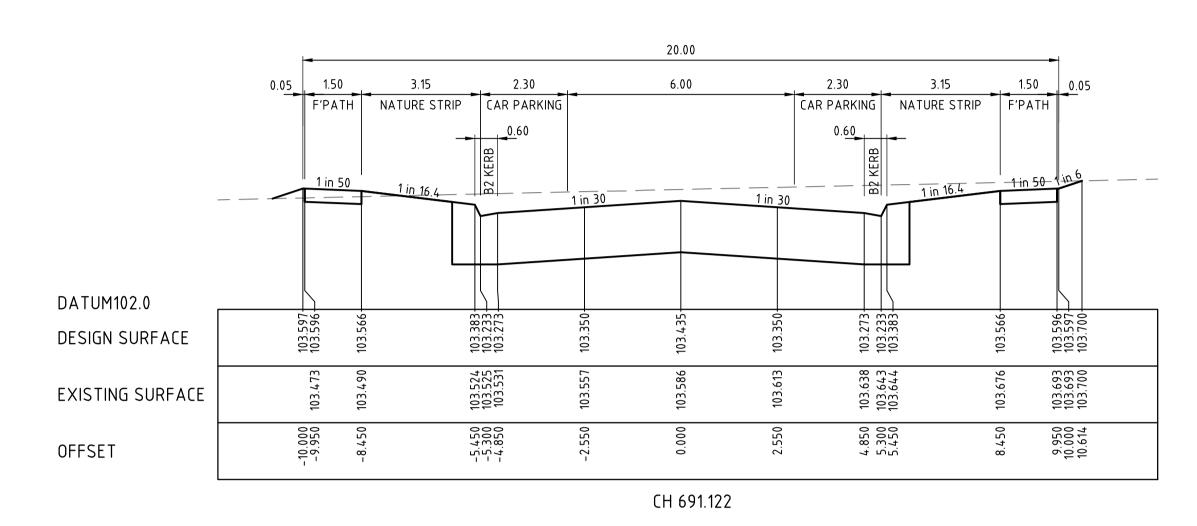

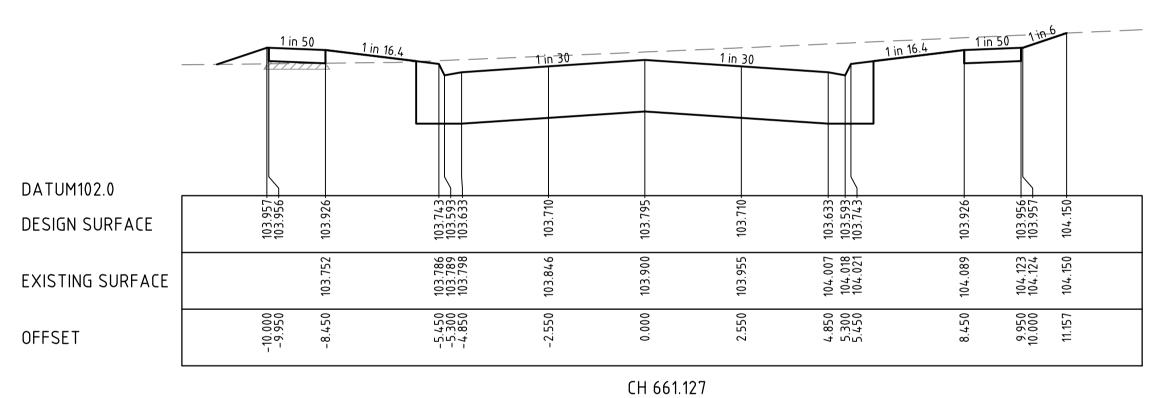

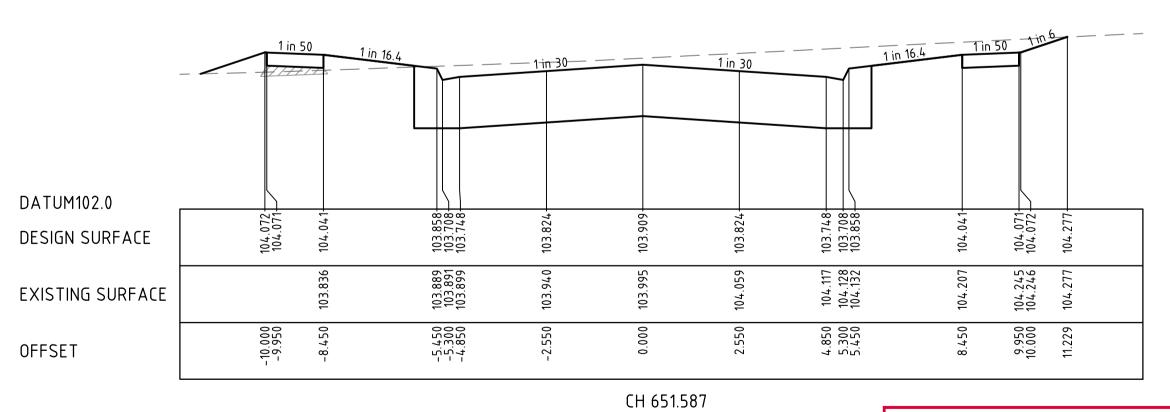

CROSS SECTIONS FUCHSIA DRIVE

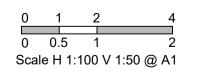

WARNING

BEWARE OF UNDERGROUND SERVICES THE LOCATIONS OF UNDERGROUND SERVICES ARE APPROXIMATE ONLY AND THEIR EXACT POSITION SHOULD BE PROVEN ON SITE PRIOR TO COMMENCEMENT OF WORK. NO GUARANTEE IS GIVEN THAT ALL EXISTING SERVICES ARE SHOWN.

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-	С	AS CONSTRUCTED	21.06.23	JZ
\	В	CONSTRUCTION ISSUE	18.01.22	JZ
7720	А	PRELIMINARY ISSUE	23.03.2020	JZ
777\:	VERSION	REMARKS		

LEGEND

COMPACTED TYPE A STRUCTURAL MATERIAL IN ACCORDANCE WITH COUNCIL TECHNICAL SPEC. SECT. 204, FROM BASE OF PAVEMENT TO 150mm BELOW NATURAL SURFACE, WITH SIDE SLOPES 1 in 0.5 MAX.

DRAWN BY	N. KASHA	DESIGNED BY	J. ZHOU
MELWAY	344, K12	CHECKED BY	L. PHAN
DATUM	AHD	AUTHORISED BY	S. RAVIDA


LAND SURVEYING **CIVIL ENGINEERING PLANNING**

DEVELOPMENT CONSULTING www.reedsconsulting.com.au engineering@reedsconsulting.com.au engineering@reedsconsulting.com.au engineering@reedsconsulting.com.au by (03) 8660 3000 Copyright Reserved 2001

CITY OF MELTON BRIDGEFIELD ESTATE, ROCKBANK STAGE 13 **FUCHSIA DRIVE**

LONGITUDINAL AND CROSS SECTIONS

VERSION DRAWING No. 13R6 REFERENCE 22236E/13

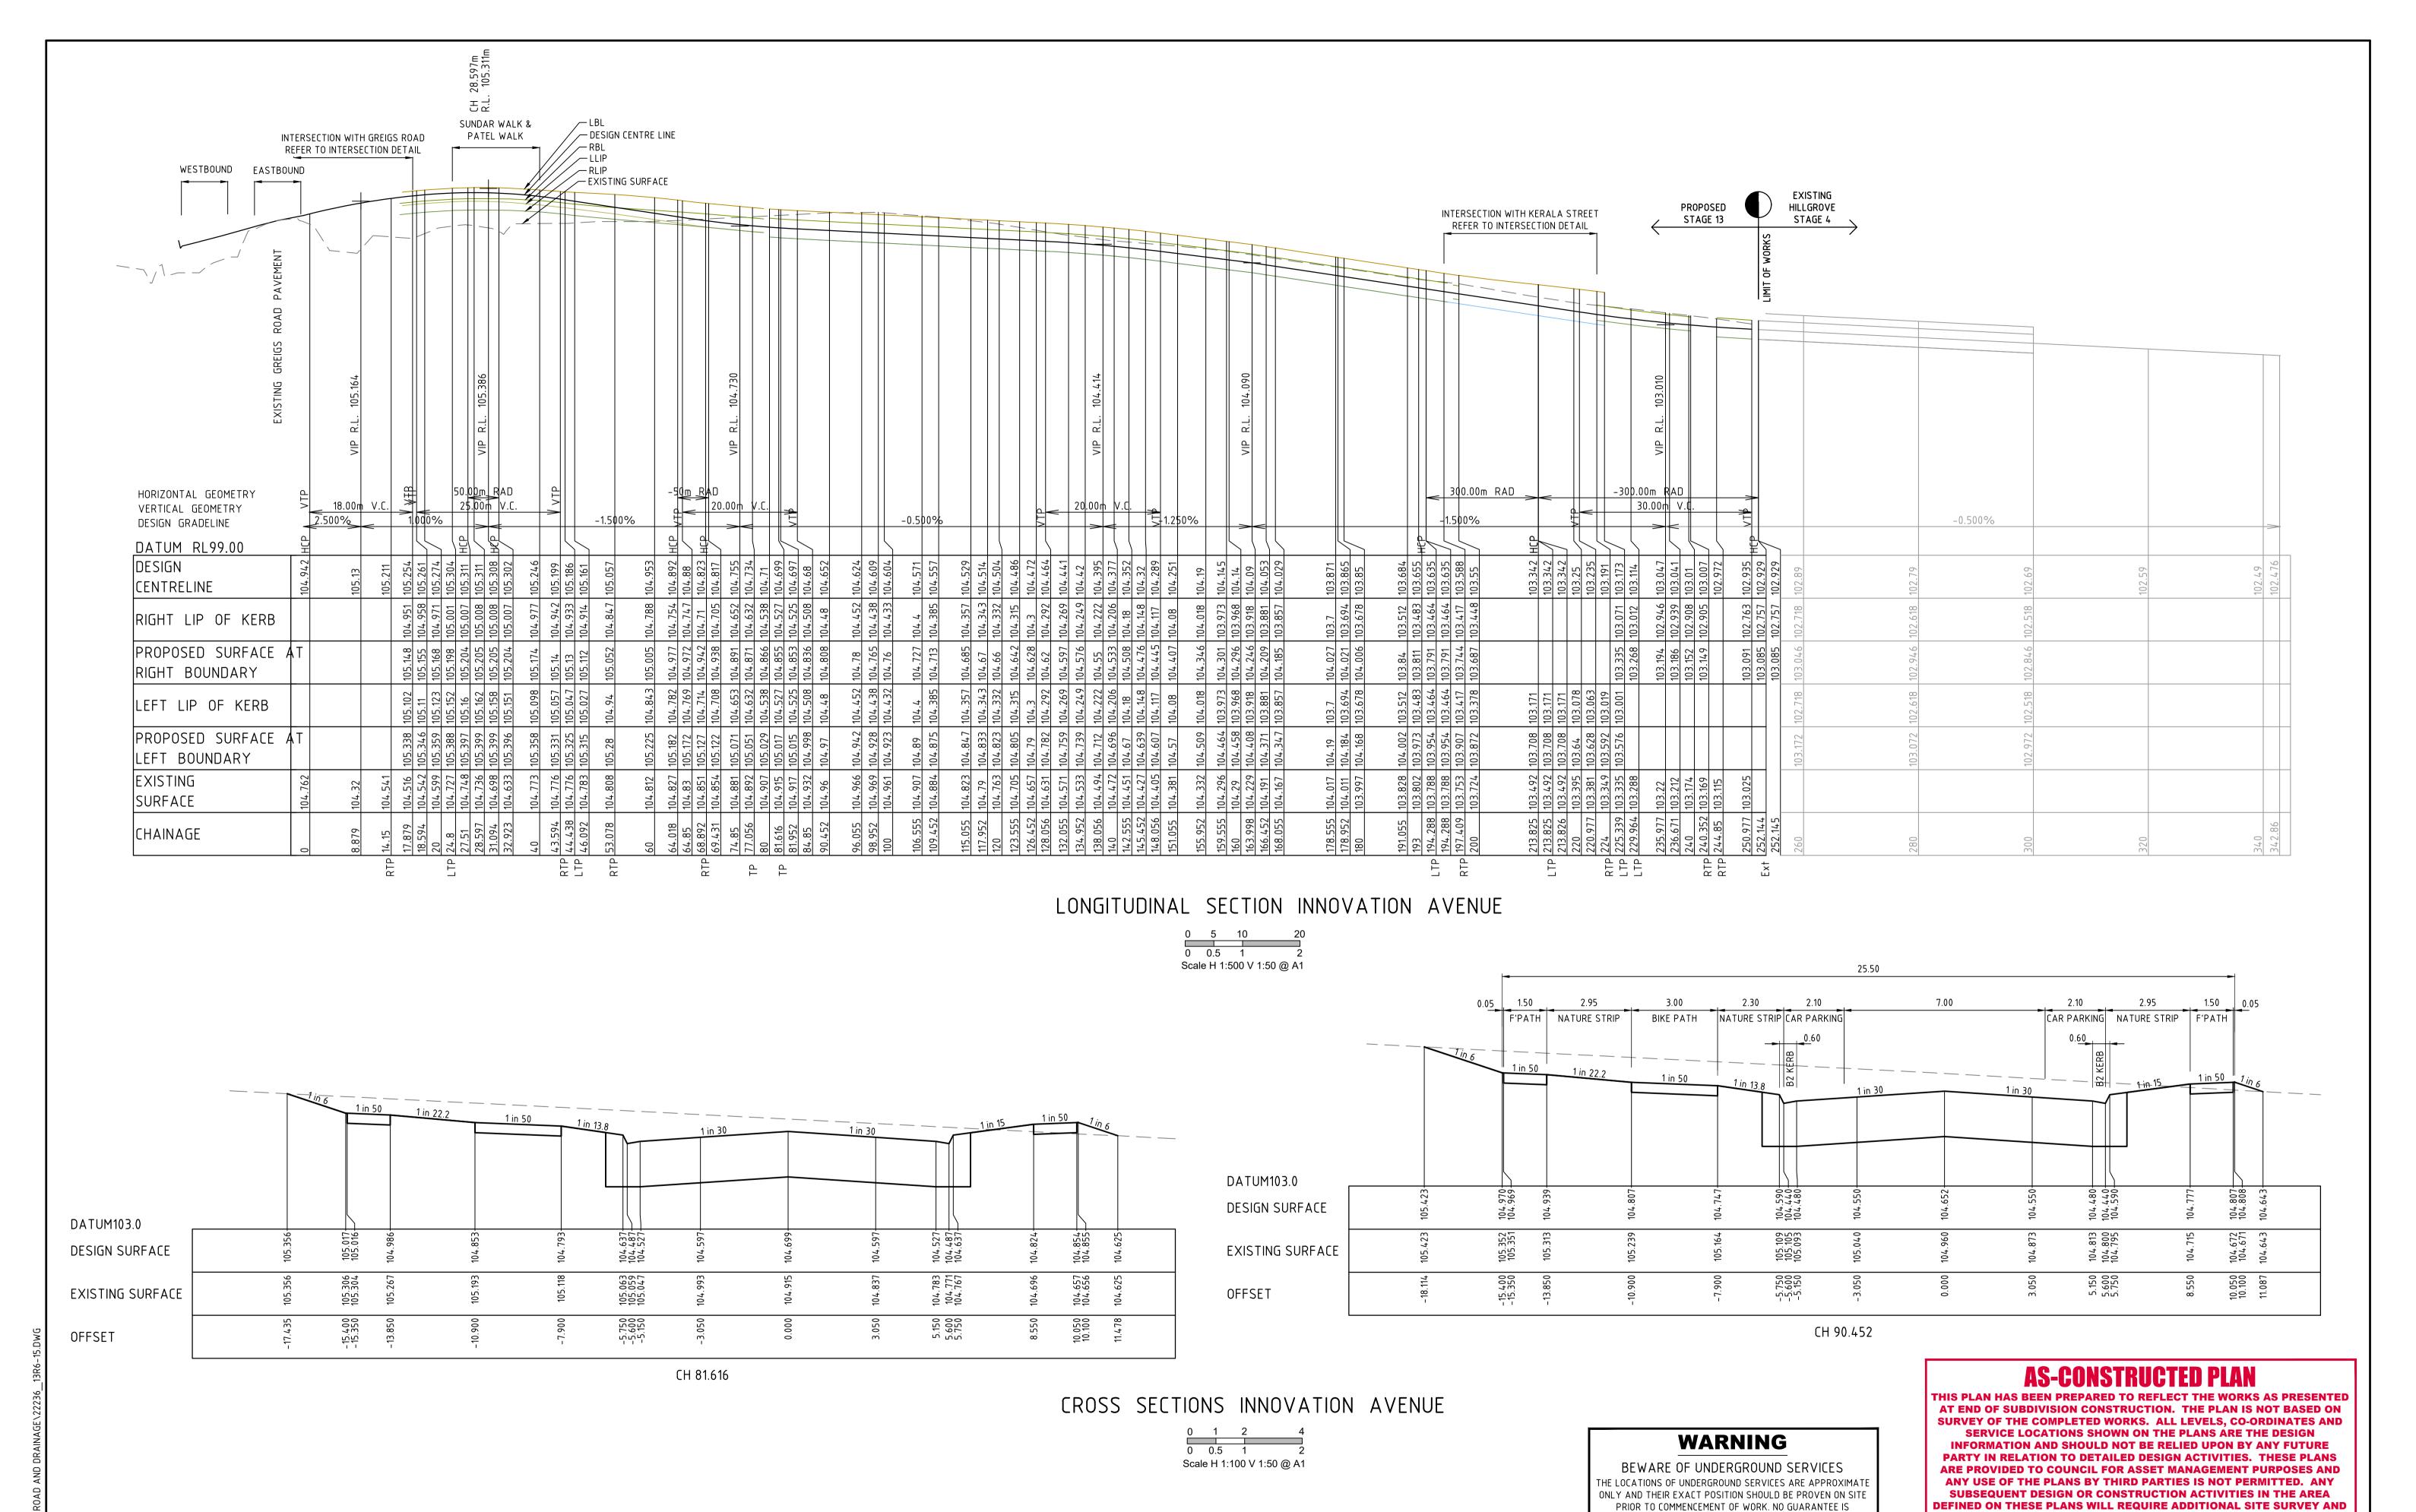

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AS CONSTRUCTED 21.06.23 JZ INNOVATION AVENUE CHO-CH40 LEVELS AMENDED 14.09.22 JZ CONSTRUCTION ISSUE 18.01.22 JZ PRELIMINARY ISSUE 23.03.2020 JZ REMARKS

LEGEND

COMPACTED TYPE A STRUCTURAL MATERIAL IN ACCORDANCE WITH COUNCIL TECHNICAL SPEC. SECT. 204, FROM BASE OF PAVEMENT TO 150mm BELOW NATURAL SURFACE, WITH SIDE SLOPES 1 in 0.5 MAX.

DRAWN BY	N. KASHA	DESIGNED BY	J. ZHOU
MELWAY	MELWAY 344, K12		L. PHAN
DATUM	AHD	AUTHORISED BY	S. RAVIDA

LAND SURVEYING CIVIL ENGINEERING

GIVEN THAT ALL EXISTING SERVICES ARE SHOWN.


DEVELOPMENT CONSULTING


CITY OF MELTON BRIDGEFIELD ESTATE, ROCKBANK STAGE 13


VERSION DRAWING No. REFERENCE 22236E/13

INNOVATION AVENUE LONGITUDINAL AND CROSS SECTIONS - 1


ASSET PROVING BY THE RELEVANT PARTY.

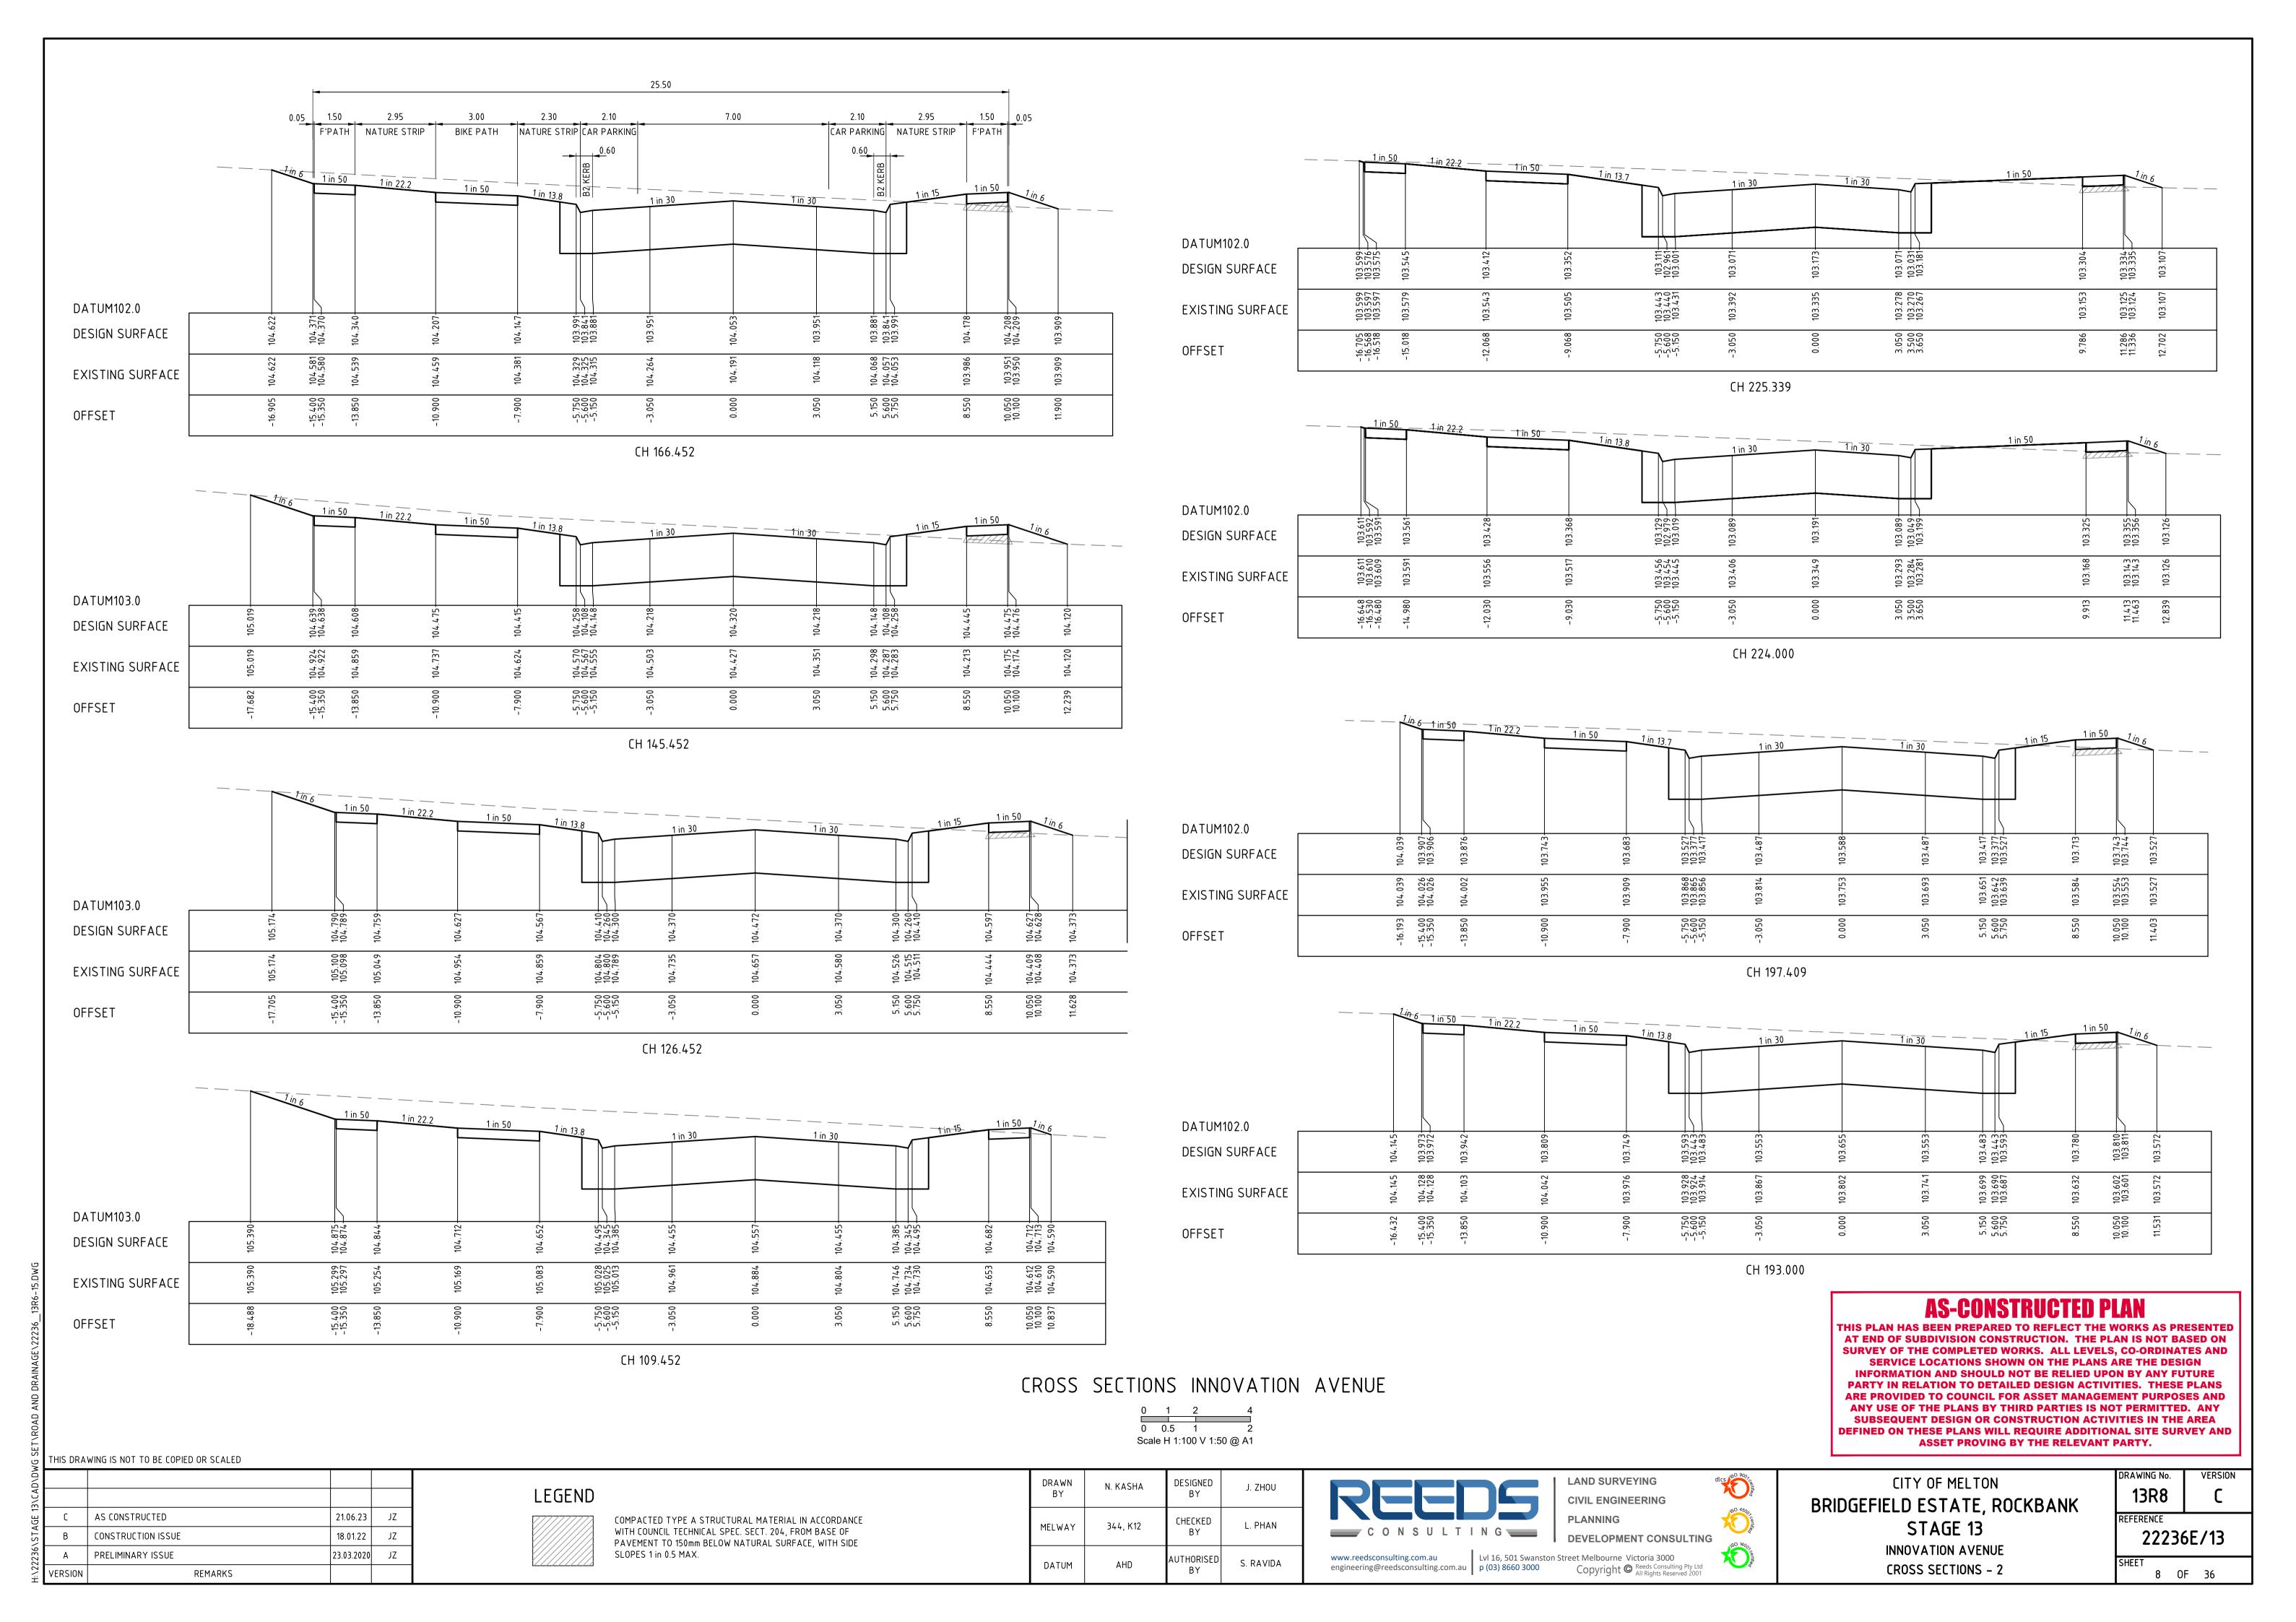


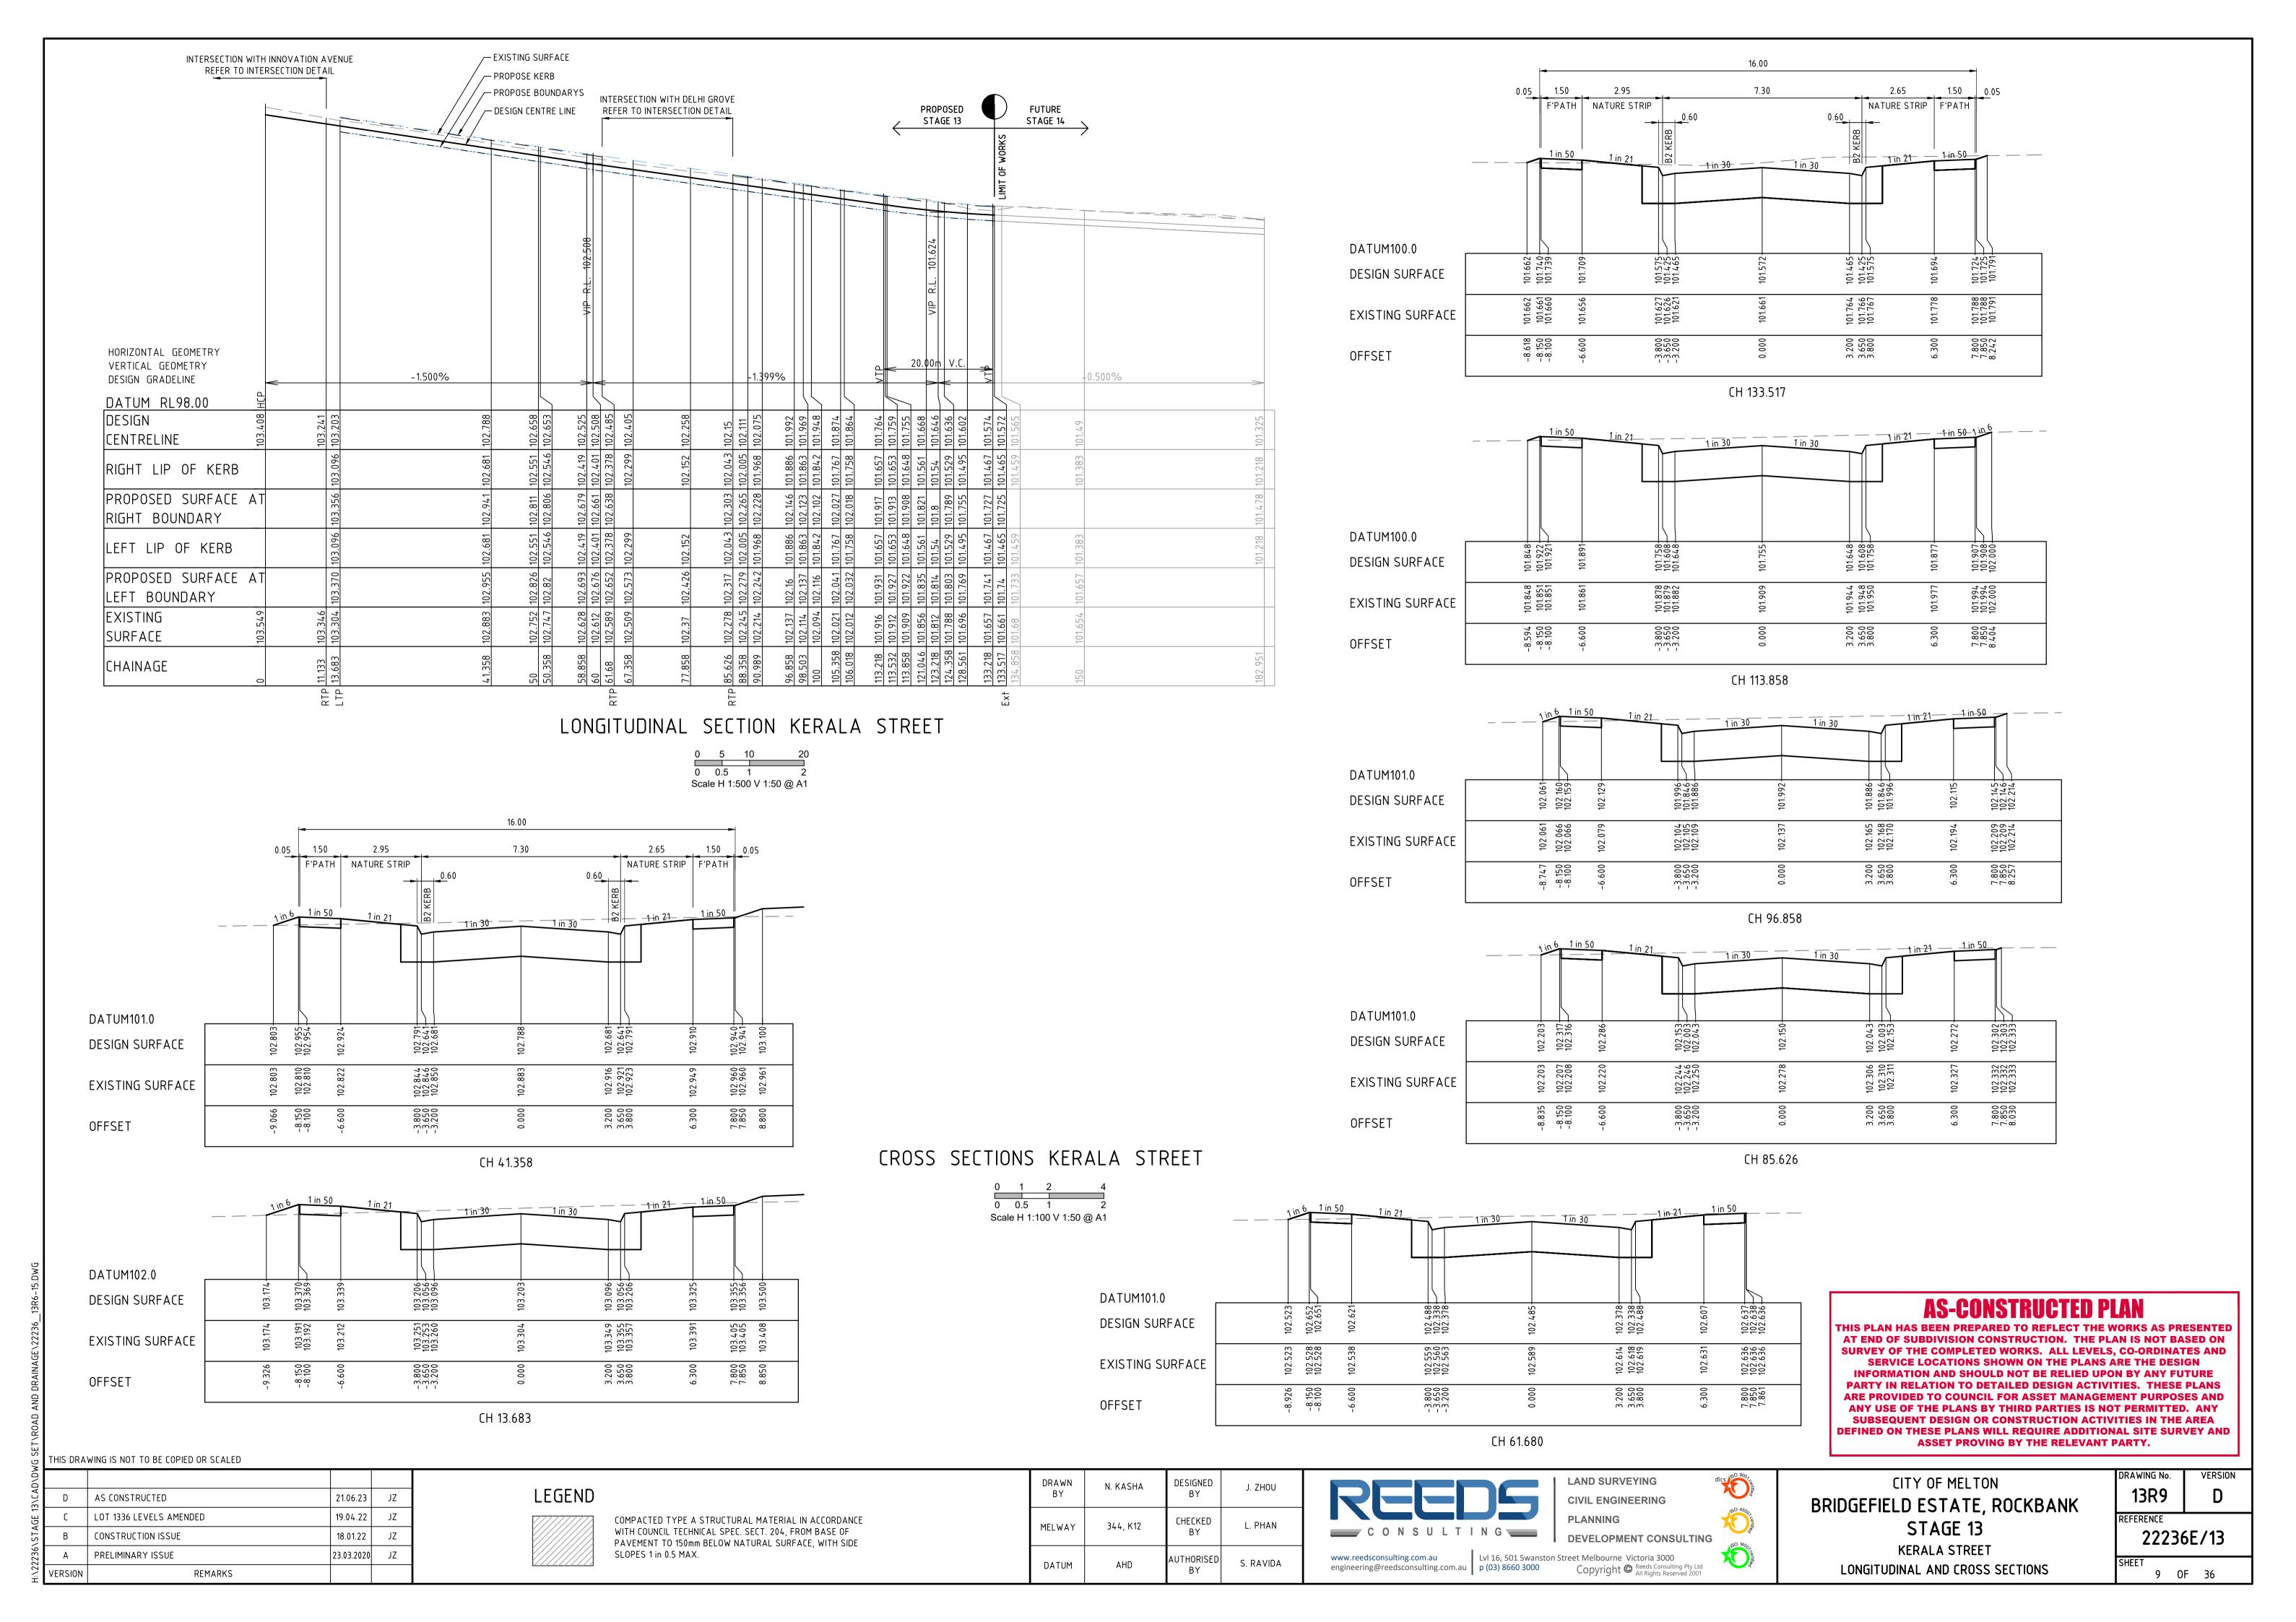

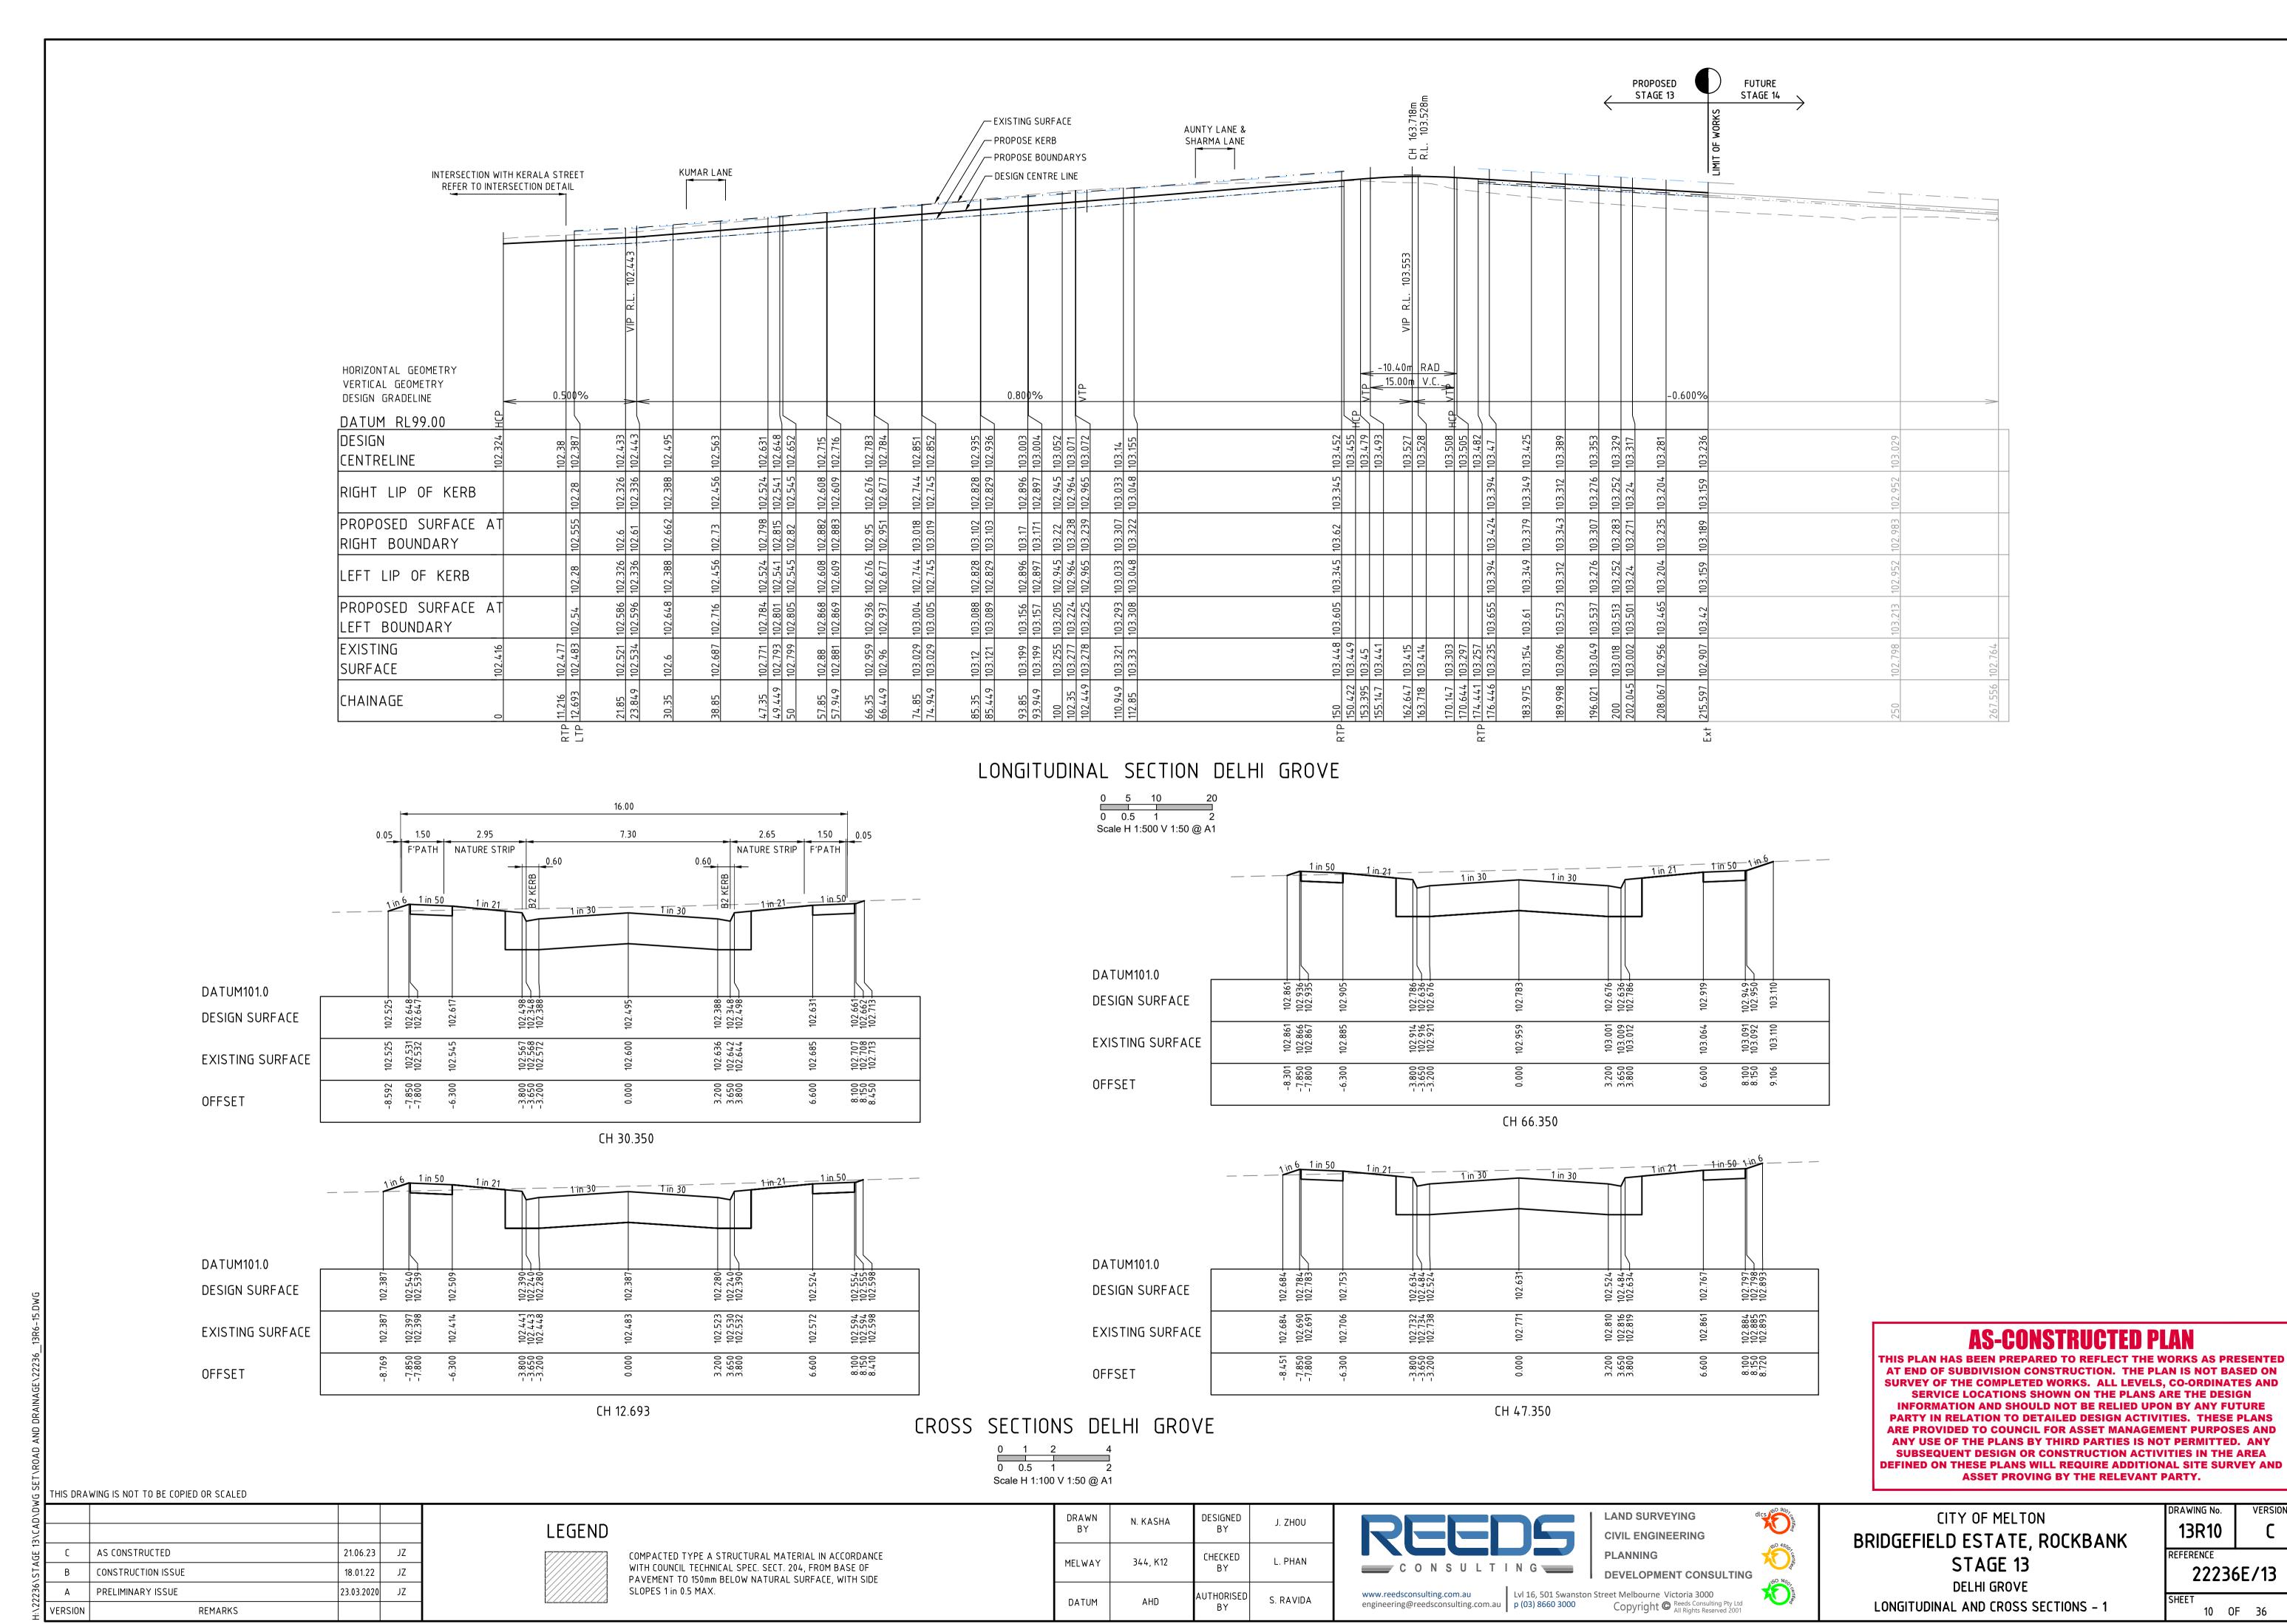


VERSION

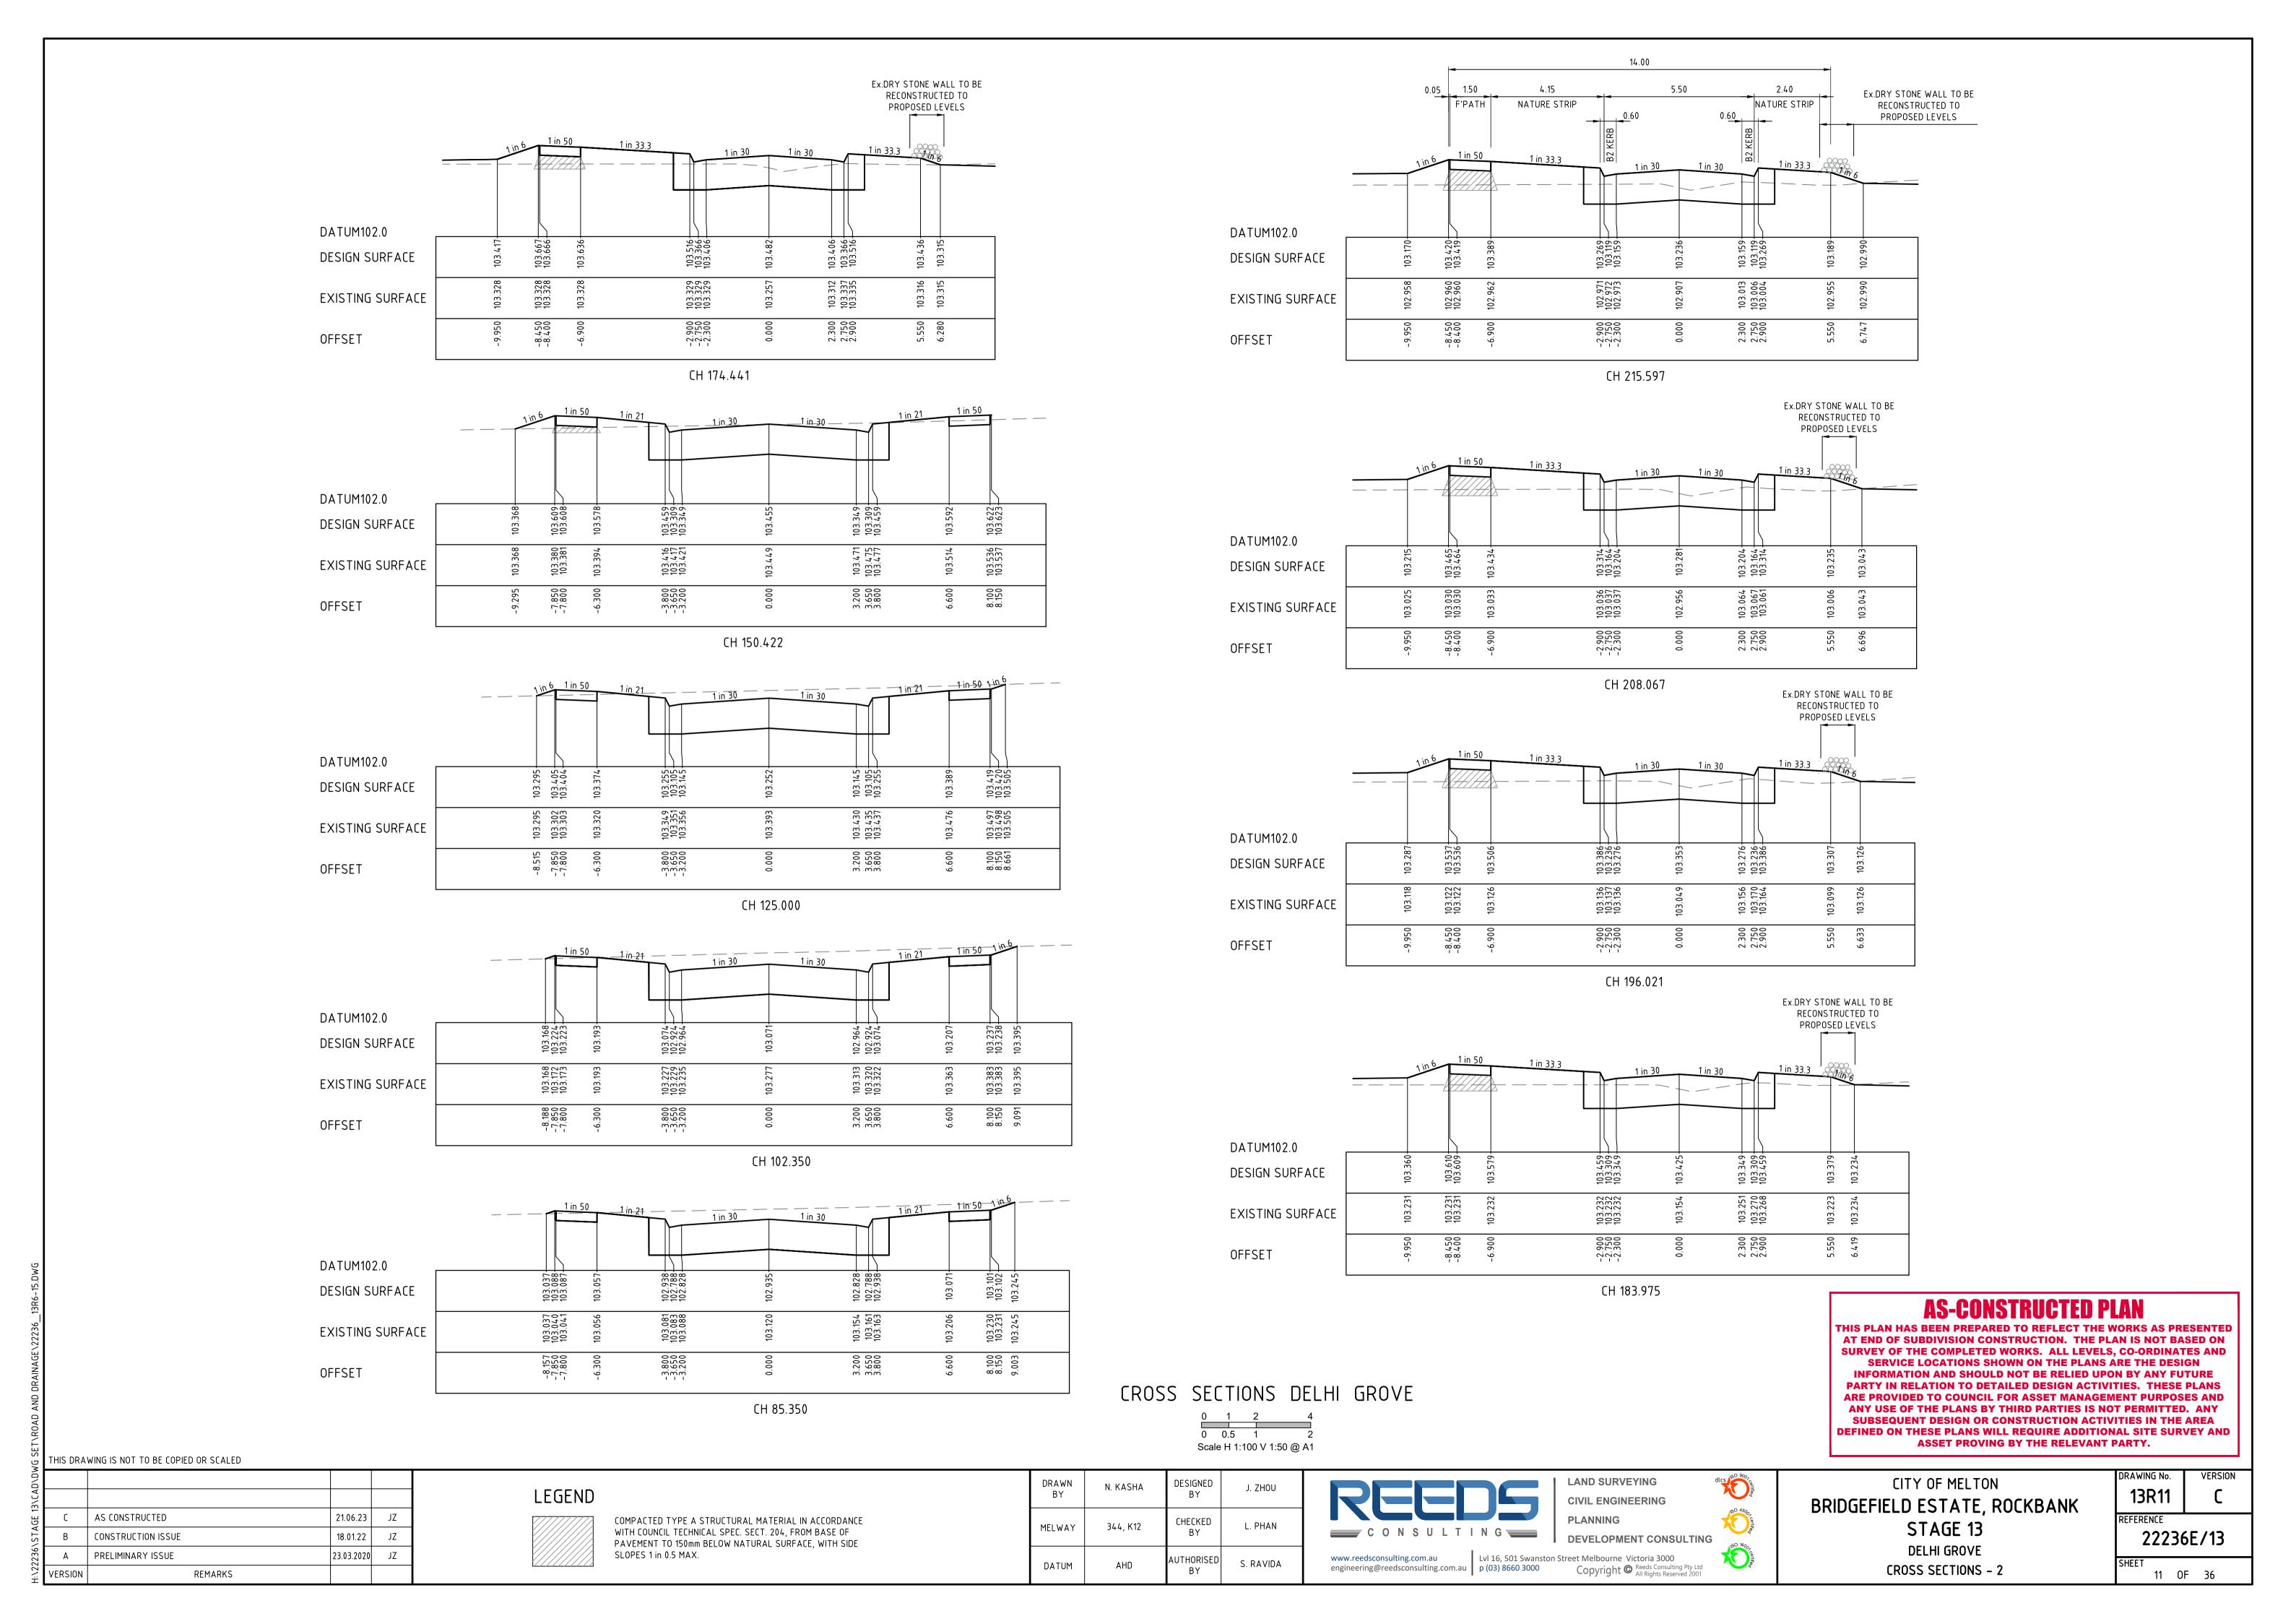

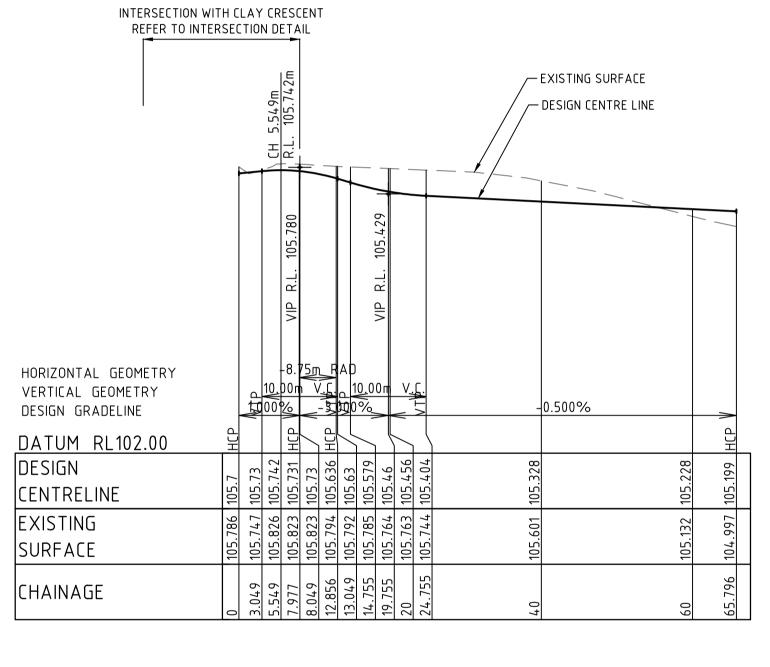

LONGITUDINAL SECTION SUNDAR PLACE

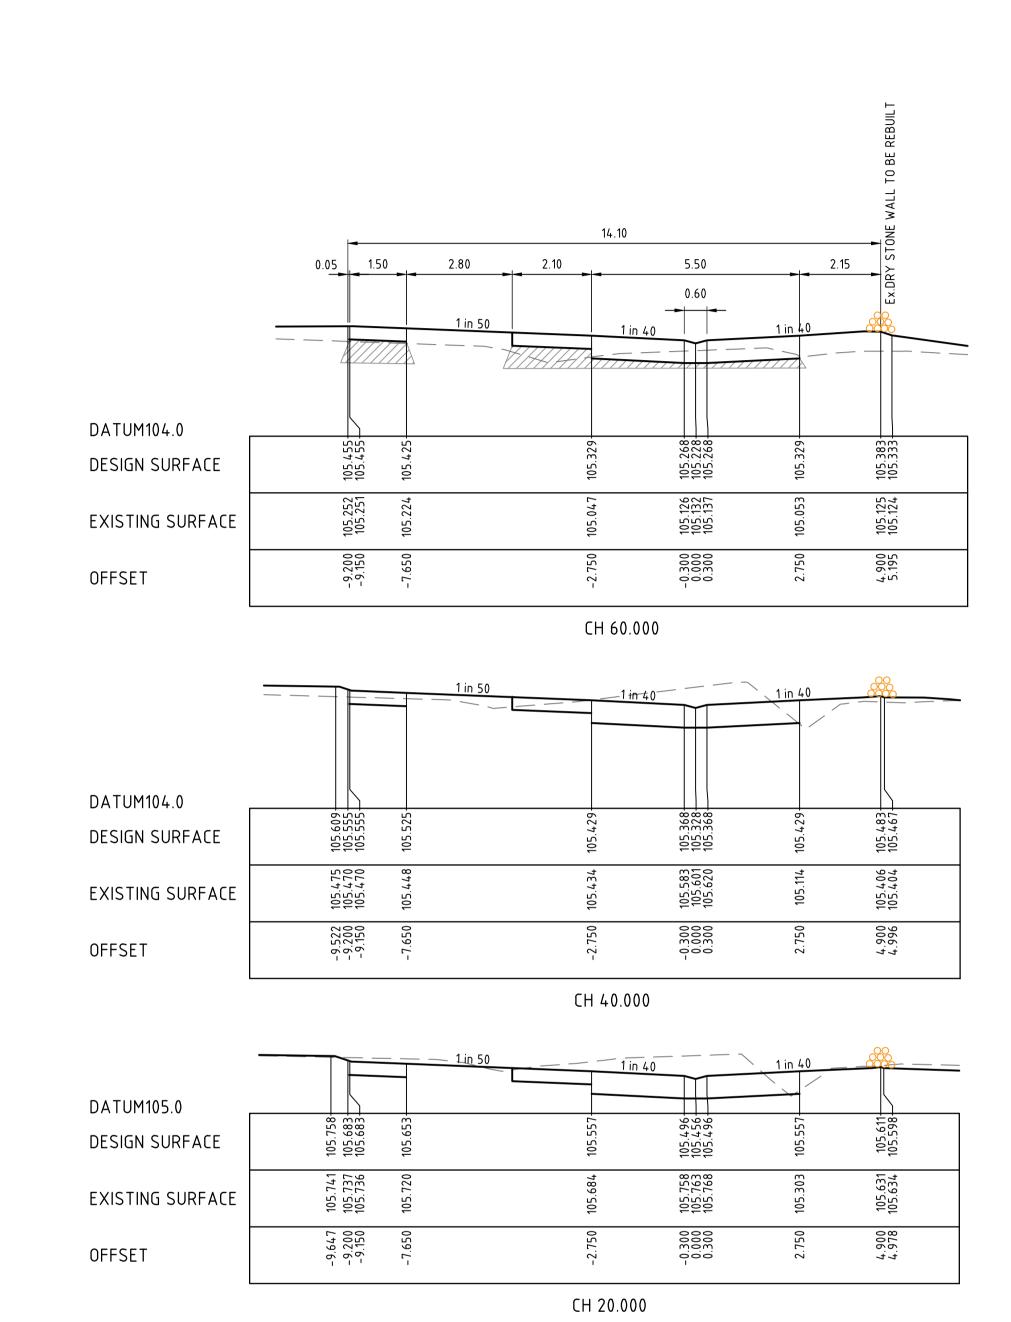

AS-CONSTRUCTED PLAN

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13\CAD\D\	D	AS CONSTRUCTED	21.06.23	JZ
GE	С	CONSTRUCTION ISSUE	18.01.2022	JZ
STA	В	SUNDAR PLACE AMENDED	10.08.2021	JZ
I:\22236\	Α	PRELIMINARY ISSUE	23.03.2020	JZ
I:\2	VERSION	REMARKS		

LEGEND

COMPACTED TYPE A STRUCTURAL MATERIAL IN ACCORDANCE WITH COUNCIL TECHNICAL SPEC. SECT. 204, FROM BASE OF PAVEMENT TO 150mm BELOW NATURAL SURFACE, WITH SIDE SLOPES 1 in 0.5 MAX.

DRAWN BY DESIGNED N. KASHA J. ZHOU CHECKED L. PHAN 344, K12 MELWAY ΒY UTHORISED S. RAVIDA DATUM AHD




LAND SURVEYING **CIVIL ENGINEERING PLANNING DEVELOPMENT CONSULTING**


CITY OF MELTON BRIDGEFIELD ESTATE, ROCKBANK STAGE 13 SUNDAR PLACE

LONGITUDINAL AND CROSS SECTIONS

VERSION DRAWING No. 13R12 REFERENCE 22236E/13

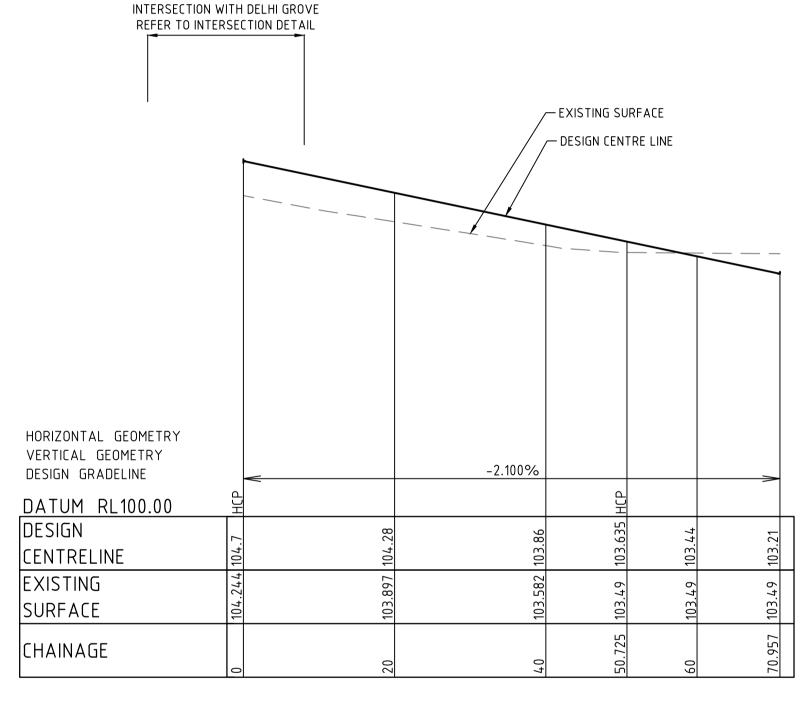

LONGITUDINAL SECTION PATEL PLACE

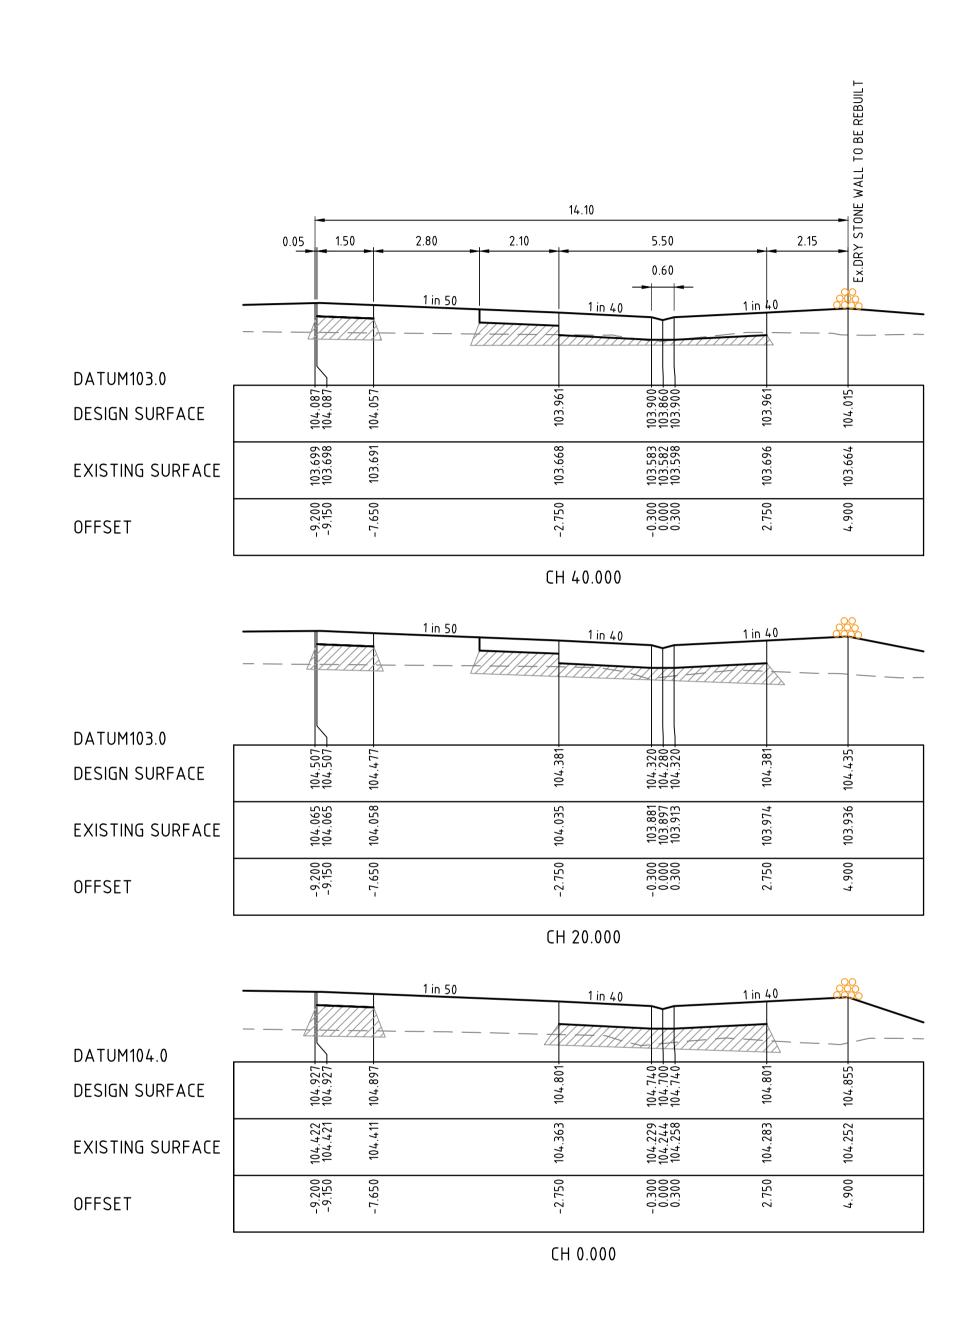

AS-CONSTRUCTED PLAN

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13\CAI	D	AS CONSTRUCTED	21.06.23	JZ
GE	С	CONSTRUCTION ISSUE	18.01.2022	JZ
۱STA	В	PATEL PLACE AMENDED	10.08.2021	JZ
22236`	Α	PRELIMINARY ISSUE	23.03.2020	JZ
:\2;	VERSION	REMARKS		

LEGEND

COMPACTED TYPE A STRUCTURAL MATERIAL IN ACCORDANCE WITH COUNCIL TECHNICAL SPEC. SECT. 204, FROM BASE OF PAVEMENT TO 150mm BELOW NATURAL SURFACE, WITH SIDE SLOPES 1 in 0.5 MAX.

DRAWN BY	N. KASHA	DESIGNED BY	J. ZHOU	
MELWAY	344, K12	CHECKED BY	L. PHAN	
DATUM	AHD	AUTHORISED BY	S. RAVIDA	




LAND SURVEYING CIVIL ENGINEERING **PLANNING DEVELOPMENT CONSULTING**

CITY OF MELTON BRIDGEFIELD ESTATE, ROCKBANK STAGE 13 PATEL PLACE

LONGITUDINAL AND CROSS SECTIONS

VERSION DRAWING No. REFERENCE 22236E/13

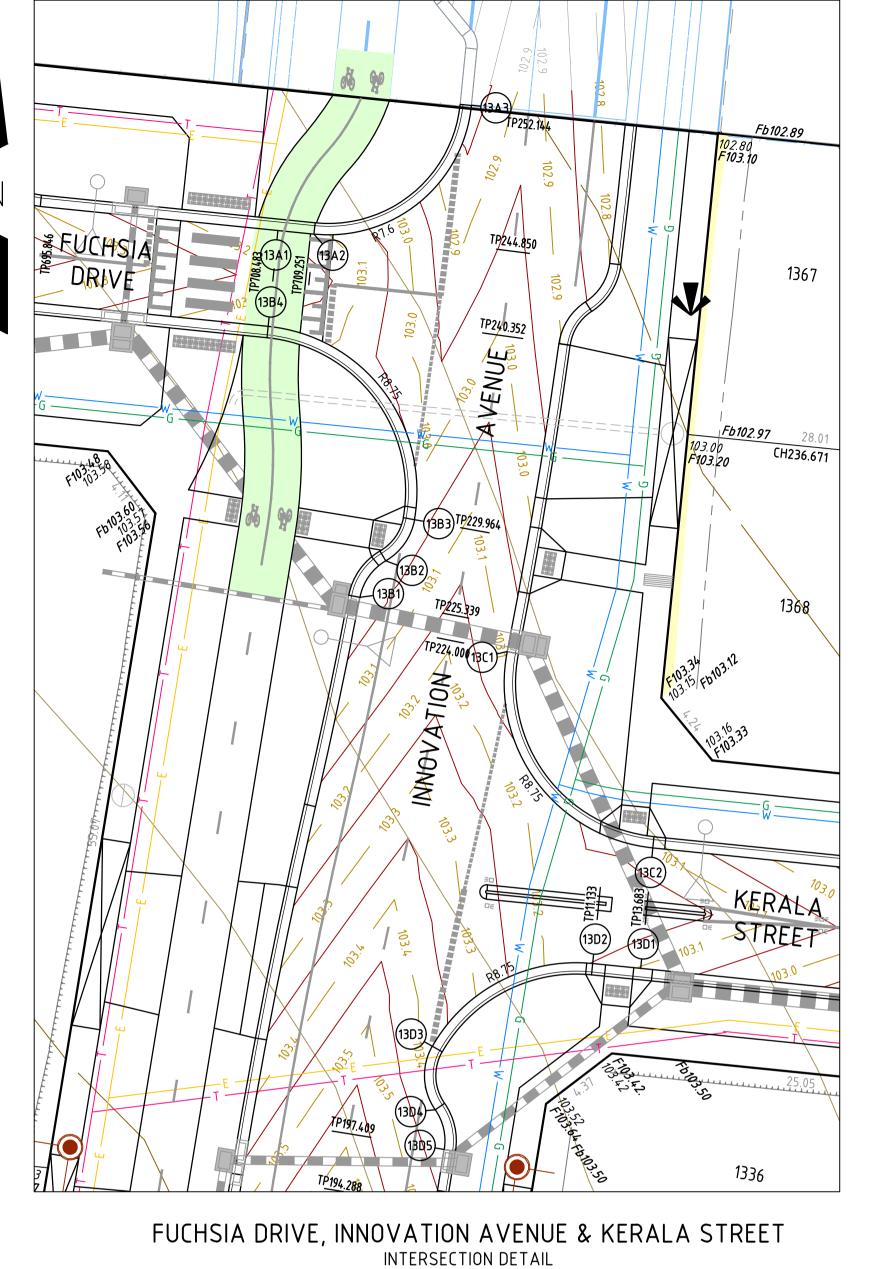


0 2 4 8 Scale 1:200 @ A1


(13A3)


_ -0.5% _

29.876 30.000

<u>-0.5%</u> ≥

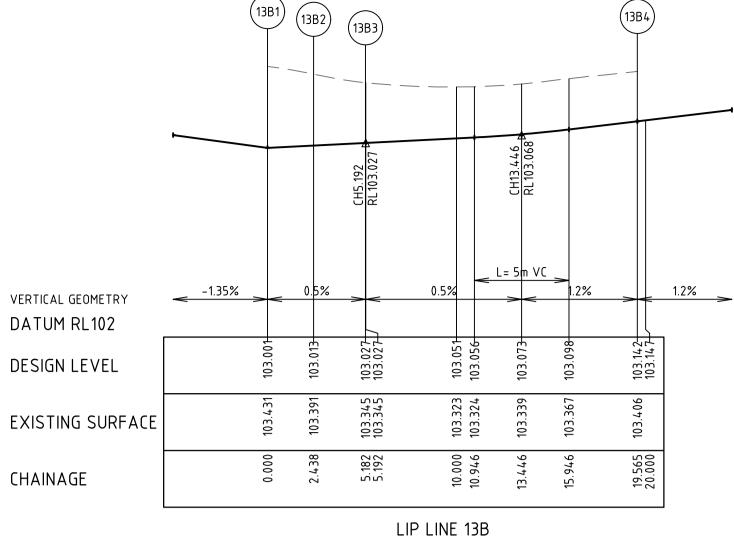

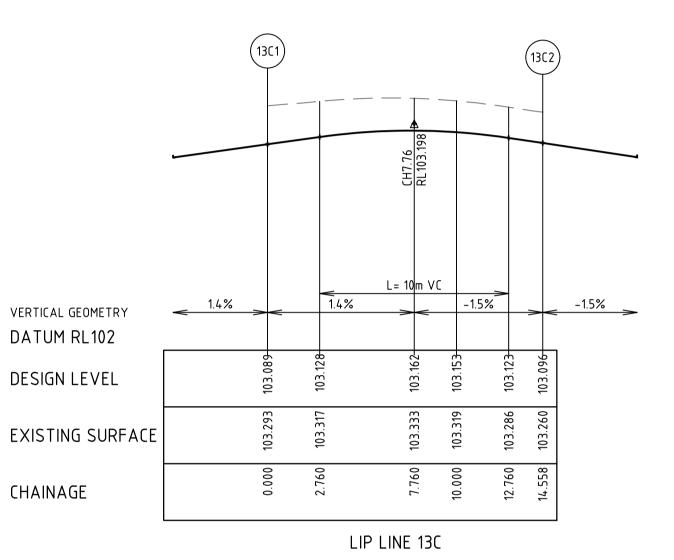

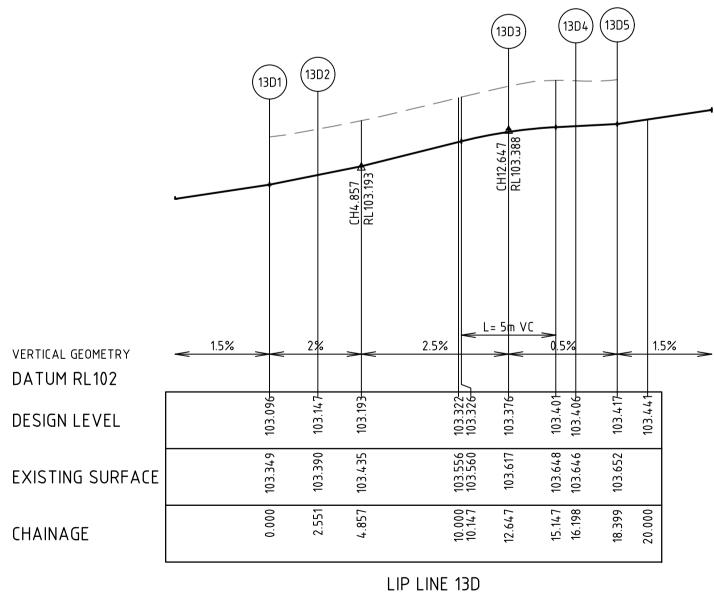



_____ 108.4_____

PAVEMENT CONTOURS



ALIGNMENT SETOUT POINT



TACTILE GROUND SURFACE INDICATORS (TGSI)
- REFER COUNCIL STD SD 3-1 & AS1428.4




TGSI LATERAL MARKER TGSI DIRECTIONAL MARKER

TGSI WARNING MARKER

NOTES

- 1. ALL DIMENSIONS REFER TO INVERT OF KERB UNLESS NOTED OTHERWISE.
- 2. SIGNS, LINEMARKING AND RRPMs SHALL BE INSTALLED IN ACCORDANCE WITH AS1742 "MANUAL OF UNIFORM TRAFFIC CONTROL DEVICES" UNLESS INDICATED OTHERWISE.
- 3. PLANS SHALL BE READ IN CONJUNCTION WITH SHEET 2 AND M.O.C.S. AS-CONSTRUCTED DATA FOR SERVICES.

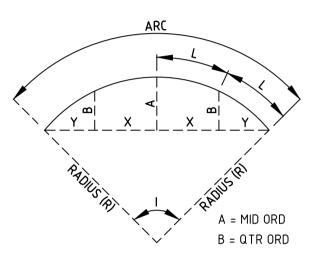

CURVE SETOUT KEY

ALL DIMENSIONS, SETOUT POINTS AND RADII REFER TO LIP OF KERB. UNLESS NOTED OTHERWISE

Alignment 13A

Point no	Easting	Northin	ig l	RL					
13A1	294051.775	5820226	5.854 10	3.142					
13 A 2	294052.538	5820226	5.776 10	3.131					
13 A 3	294062.126	5820234	.609 10	2.816					
Curve no		Radius	Агс	Α	В	X	Y	Į	Mid point RL
13A2 - 13 <i>i</i>	43 90.050	8.750	13.752	2.566	1.899	3.350	2.840	3.438	102.952

Alignment 13B

Point no	Easting	Northii	ng	RL					
13B1	294056.109	5820207	.452 10	3.001					
13B2	294057.477	5820209	.381 103	3.013					
13B3	294058.998	5820211	.560 103	3.027					
13B4	294051.261	5820221	.779 103	3.142					
Curve no		Radius	Агс	Α	В	X	Y	Į	Mid point RL
13B1 - 13B2	49.018	2.850	2.438	0.257	0.192	0.605	0.577	0.610	103.007
13B2 - 13B	3 49.901	3.150	2.743	0.294	0.220	0.680	0.648	0.686	103.020
13B3 – 13B	4 94.186	8.750	14.384	2.793	2.064	3.496	2.913	3.596	103.064

Alignment 13C

Point no	Easting	Northi	ng	RL					
13C1	294063.905	5820204	+.581	103.089					
13C2	294071.610	5820194	.191	103.096					
Curve no	I	Radius	Агс	А	В	X	Y	l	Mid point R
13C1 - 13C2	95.325	8.750	14.558	2.857	2.111	3.535	2.933	3.639	103.162

Alignment 13D

Point no	Easting	Northi	ng	RL					
13D1	294070.966	5820187	.823	103.096					
13D2	294068.428	5820188	3.080	103.147					
13D3	294059.944	582018	3.705	103.376					
13D4	294060.099	5820180	0.343	103.406					
13D5	294060.575	5820178	3.249	103.417					
Curve no	1	Radius	Агс	Α	В	X	Y	Į	Mid point RL
13D2 - 13D3	3 66.113	8.750	10.096	1.416	1.055	2.489	2.284	2.524	103.262
13D3 - 13D4	4 64.594	3.150	3.551	0.487	0.363	0.876	0.807	0.888	103.396
13D4 - 13D	5 44.244	2.850	2.201	0.210	0.157	0.547	0.526	0.550	103.411

WARNING

BEWARE OF UNDERGROUND SERVICES THE LOCATIONS OF UNDERGROUND SERVICES ARE APPROXIMATE ONLY AND THEIR EXACT POSITION SHOULD BE PROVEN ON SITE PRIOR TO COMMENCEMENT OF WORK. NO GUARANTEE IS GIVEN THAT ALL EXISTING SERVICES ARE SHOWN.

THIS PLAN HAS BEEN PREPARED TO REFLECT THE WORKS AS PRESENTED AT END OF SUBDIVISION CONSTRUCTION. THE PLAN IS NOT BASED ON SURVEY OF THE COMPLETED WORKS. ALL LEVELS, CO-ORDINATES AND SERVICE LOCATIONS SHOWN ON THE PLANS ARE THE DESIGN **INFORMATION AND SHOULD NOT BE RELIED UPON BY ANY FUTURE** PARTY IN RELATION TO DETAILED DESIGN ACTIVITIES. THESE PLANS ARE PROVIDED TO COUNCIL FOR ASSET MANAGEMENT PURPOSES AND ANY USE OF THE PLANS BY THIRD PARTIES IS NOT PERMITTED. ANY SUBSEQUENT DESIGN OR CONSTRUCTION ACTIVITIES IN THE AREA DEFINED ON THESE PLANS WILL REQUIRE ADDITIONAL SITE SURVEY AND ASSET PROVING BY THE RELEVANT PARTY.

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VERTICAL GEOMETRY

DATUM RL102

DESIGN LEVEL

CHAINAGE

EXISTING SURFACE

>						
)U\(DRAIN, PROPERTY INLET & PIT	LEGEND
Αſ					EX DRAIN & PIT	
ý					HOUSE DRAIN	EXRW EX RECYCLED WATER
13					S SEWER AND MAINTENANCE HOLE	E ELECTRICAL U.G. SERVICES
GE	C	AS CONSTRUCTED	21.06.23	JZ	——————————————————————————————————————	—— — ExE—— —— EX ELECTRICAL U.G. SERVICES
₹					WATER MAIN	E ELECTRICAL SERVICE & PIT
ST	В	CONSTRUCTION ISSUE	18.01.22	JZ	→ ExW F.H. EX WATER MAIN, VALVE & HYDRANT Output Description: Output Description: EX WATER MAIN, VALVE & HYDRANT Output Description: Output	LIGHT ● POLE • PIT EX ELECTRICAL ASSETS
9					G GAS MAIN	EX ELECTRICAL OVERHEADS
23	Α	PRELIMINARY ISSUE	23.03.20	JZ	→ —ExG—— — EX GAS MAIN, VALVE	
22	1/5001011	DEMARKS			TELSTRA SERVICES & PITS	— · · · — · · · — TOP OF BATTER
-	VERSION	REMARKS			EXT— EX TELSTRA SERVICES & PITS	TOE OF BATTER

LIP LINE 13A

-1.2% -1.2% -3.64%

357 124

<i>F</i> <i>Fb</i> P	FINISHED SURFACE AFTE TOP OF PROPOSED BAT PROPOSED PAVEMENT O	TER		DRAWN BY	N. KASHA	DESIGNED BY	J. ZHOU
IL TP CH	EXISTING OR PROPOSED OR OPEN DRAIN TANGENT POINT CHAINAGE			MELWAY	344, K12	CHECKED BY	L. PHAN
^	PSM		ТВМ	DATUM	AHD	AUTHORISED BY	S. RAVIDA

LIP PROFILE

Scale H 1:100 V 1:50 @ A1


LAND SURVEYING **CIVIL ENGINEERING**

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CITY OF MELTON BRIDGEFIELD ESTATE, ROCKBANK STAGE 13 INTERSECTION DETAILS AND LIP PROFILE - 1

VERSION DRAWING No. 13R16 REFERENCE 22236E/13

SHEET 16 OF 36

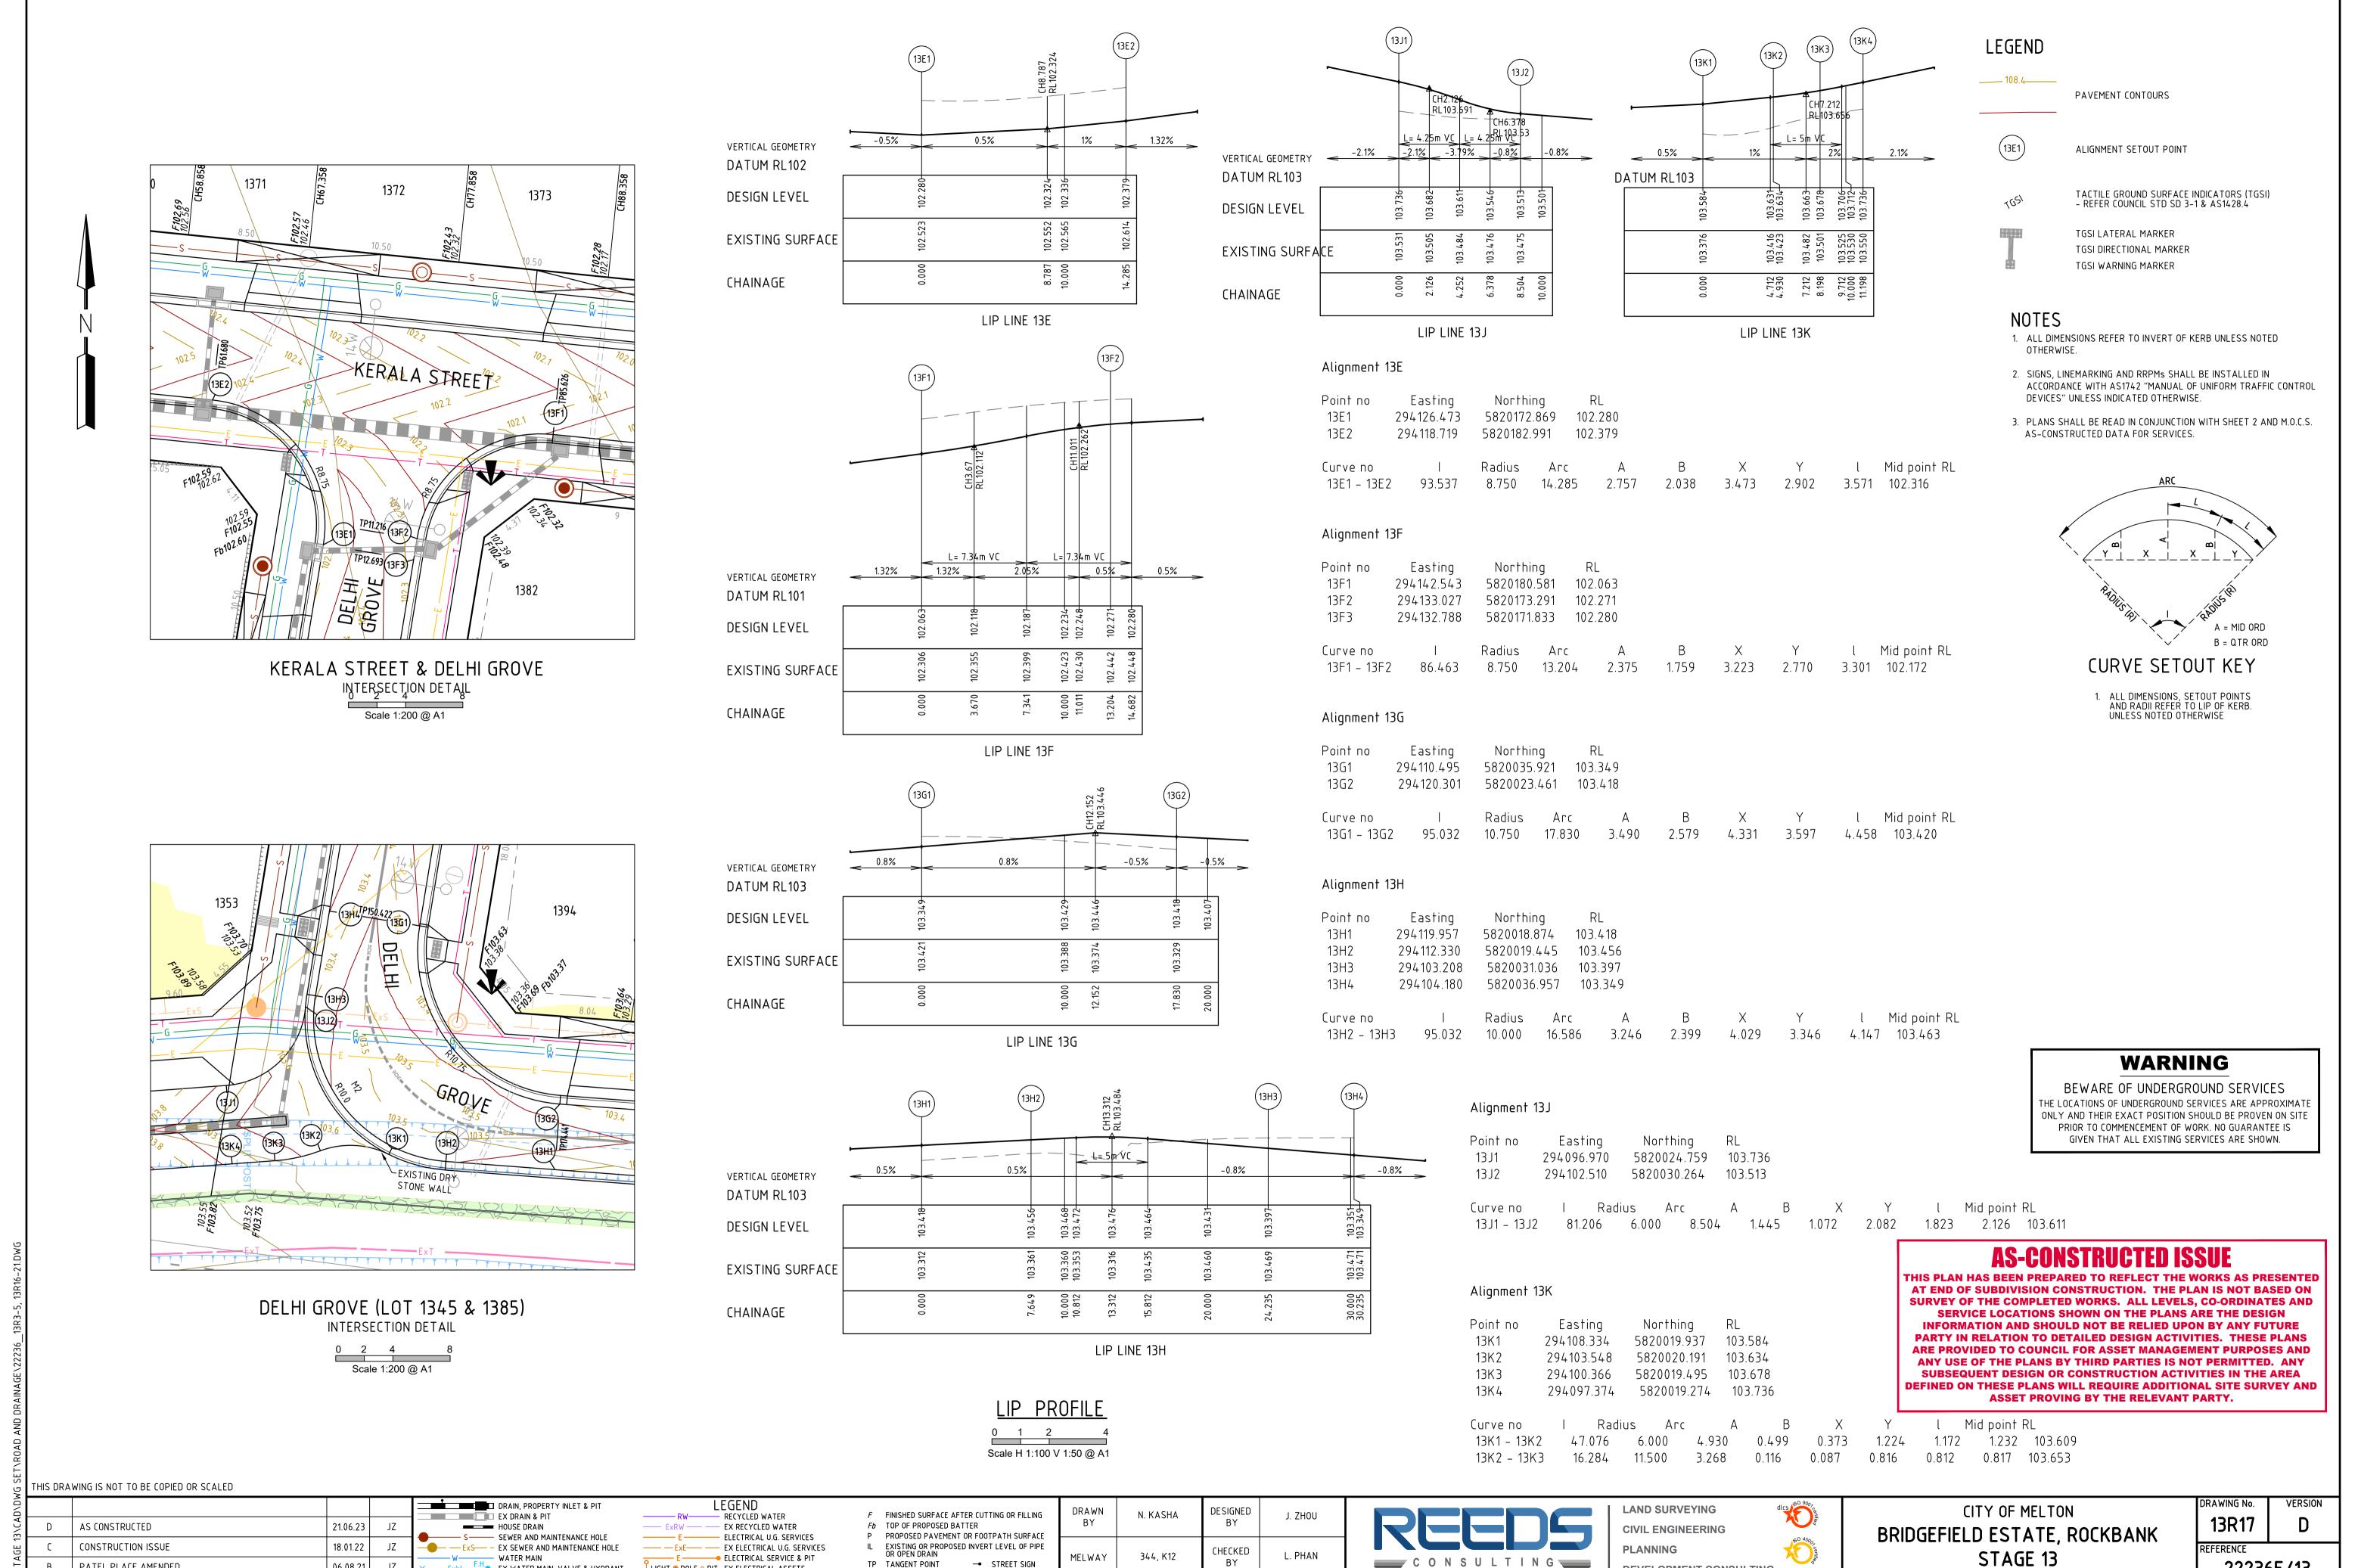

ΒY

UTHORISED

S. RAVIDA

DEVELOPMENT CONSULTING

→ STREET SIGN

入 TBM

EX WALL OR BUILDING

EX FENCE

② DRAINAGE PIT No.

DATUM

 AHD

TP TANGENT POINT

CH CHAINAGE

♠ PSM

LIGHT ● POLE • PIT EX ELECTRICAL ASSETS

------ GW------ GAS & WATER CONDUITS

— · · — · · — TOP OF BATTER

_____ - - ____ TOE OF BATTER

EX ELECTRICAL OVERHEADS

EX WATER MAIN, VALVE & HYDRANT

- EX TELSTRA SERVICES & PITS

GAS MAIN

T—T—TELSTRA SERVICES & PITS

— EX GAS MAIN, VALVE

PATEL PLACE AMENDED

REMARKS

PRELIMINARY ISSUE


06.08.21


23.03.2020 JZ

22236E/13

17 OF 36

INTERSECTION DETAILS AND LIP PROFILE - 2

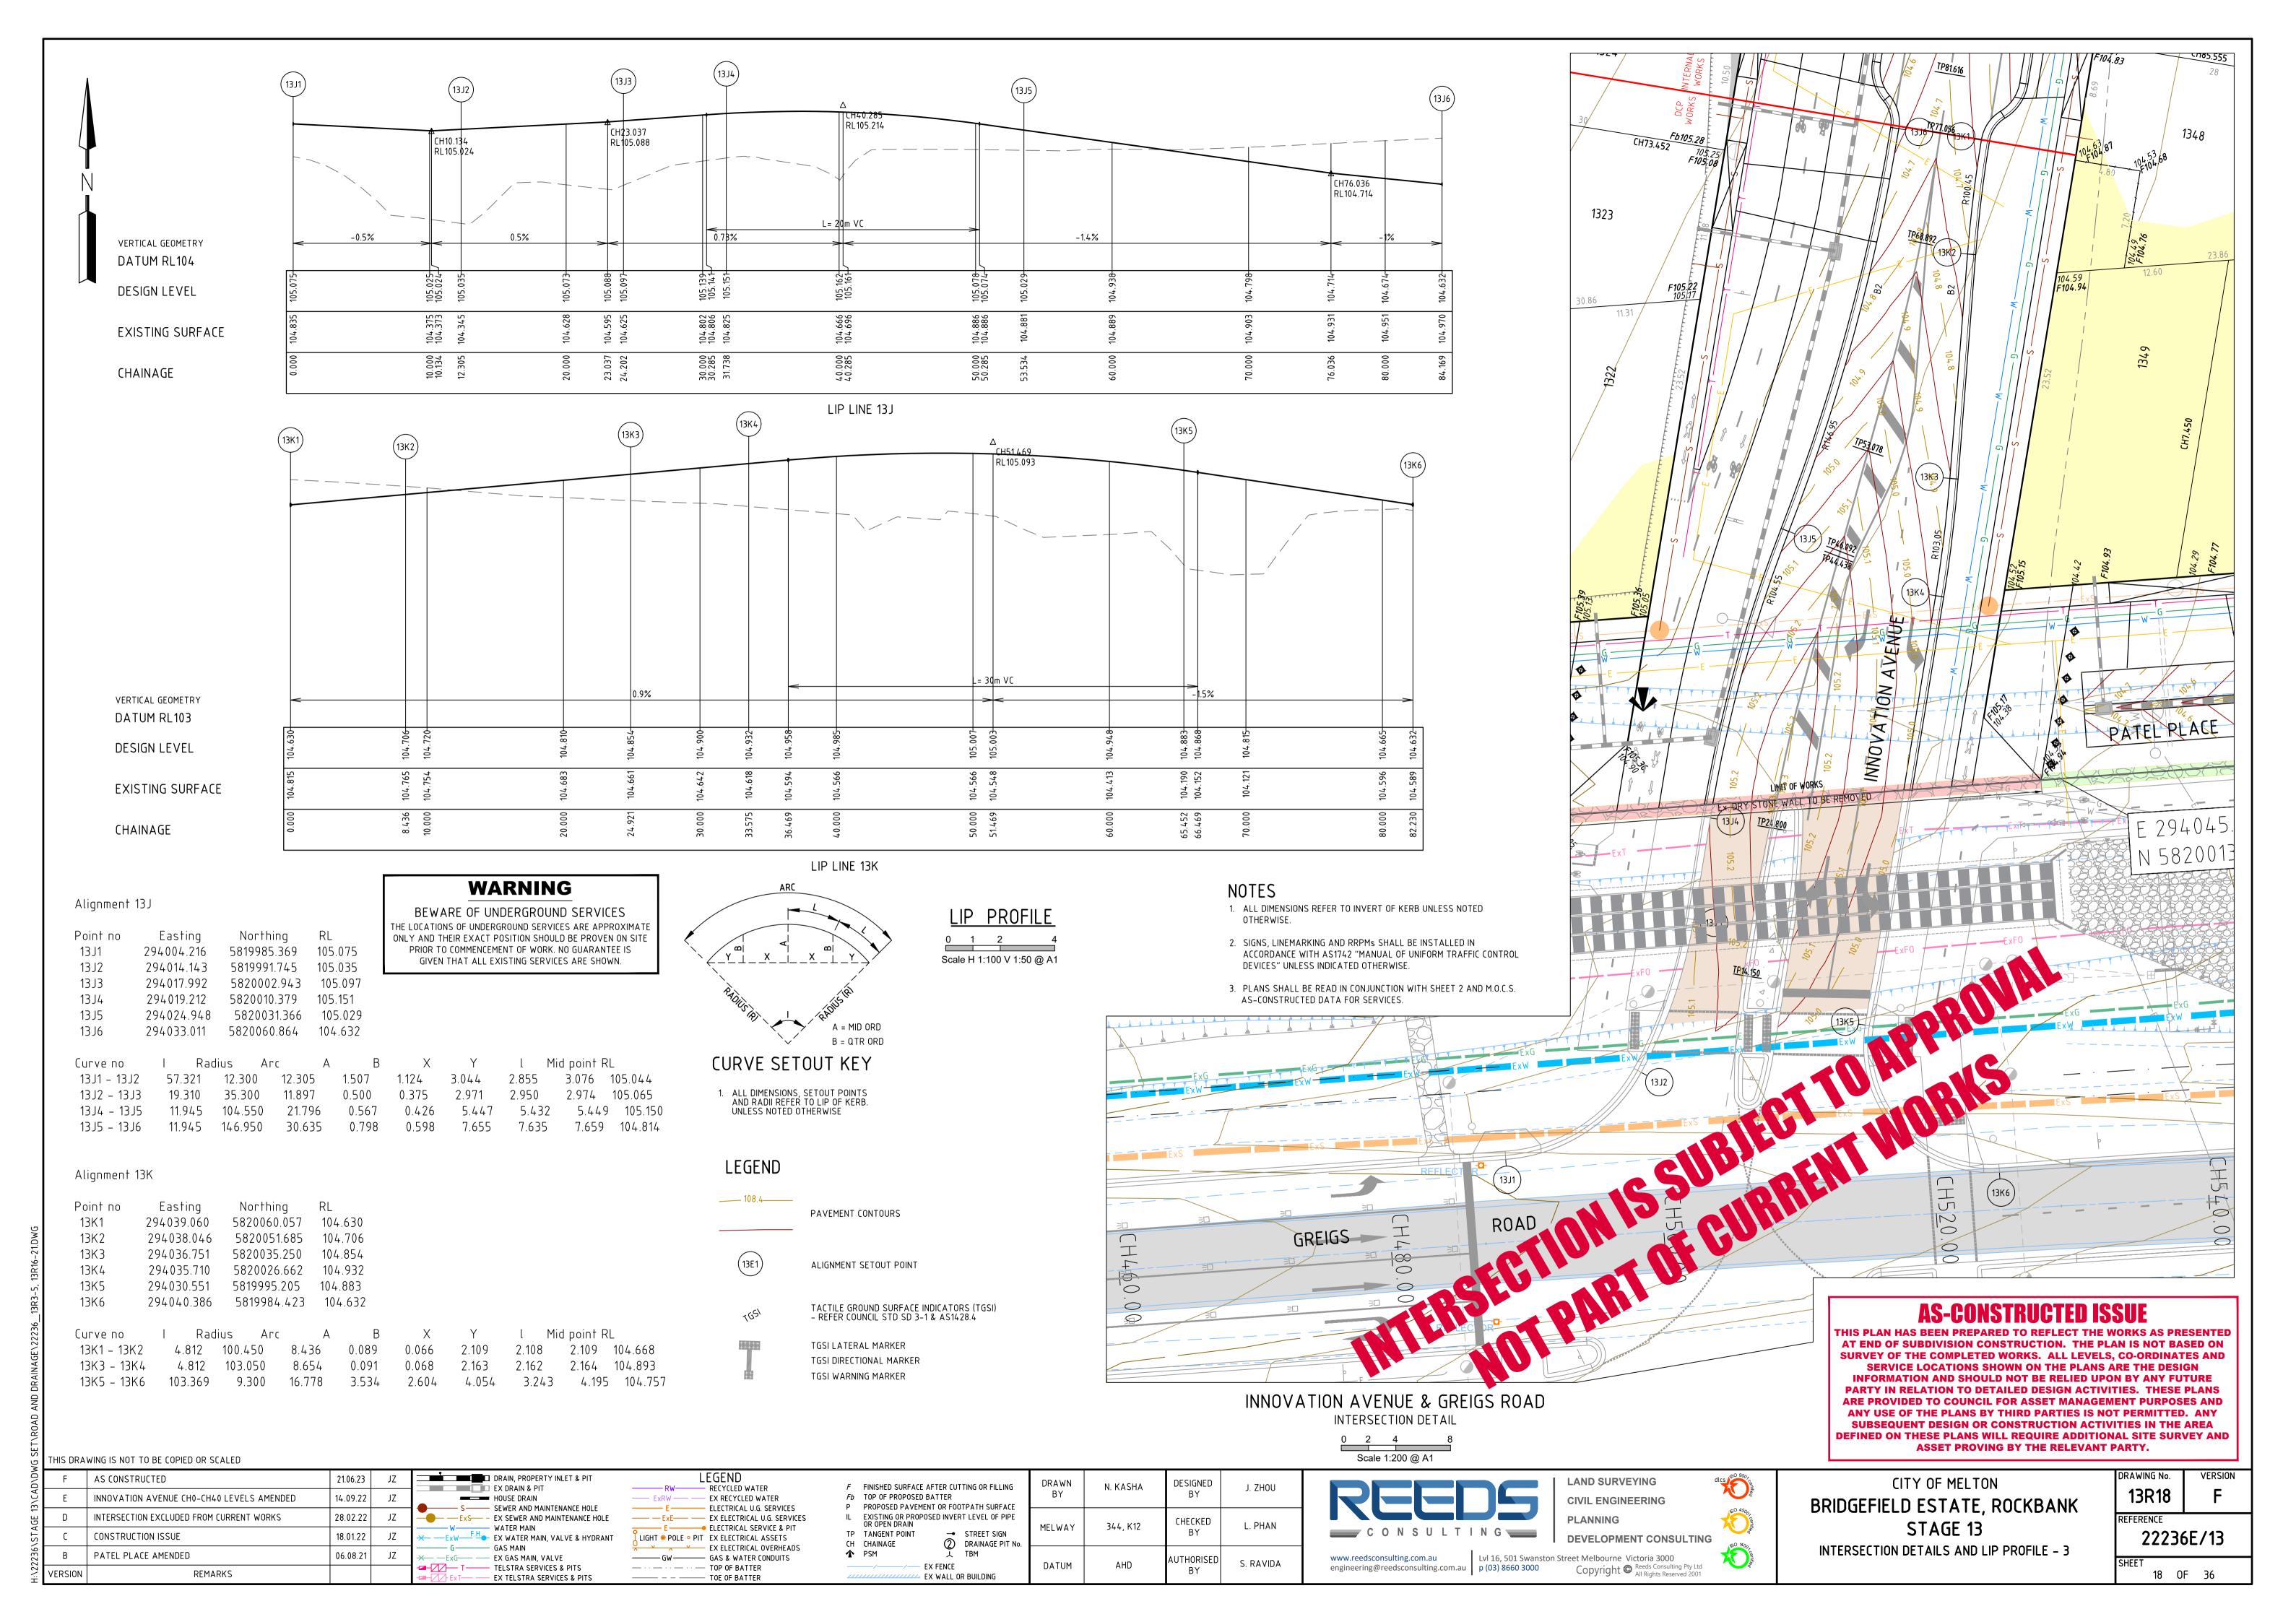

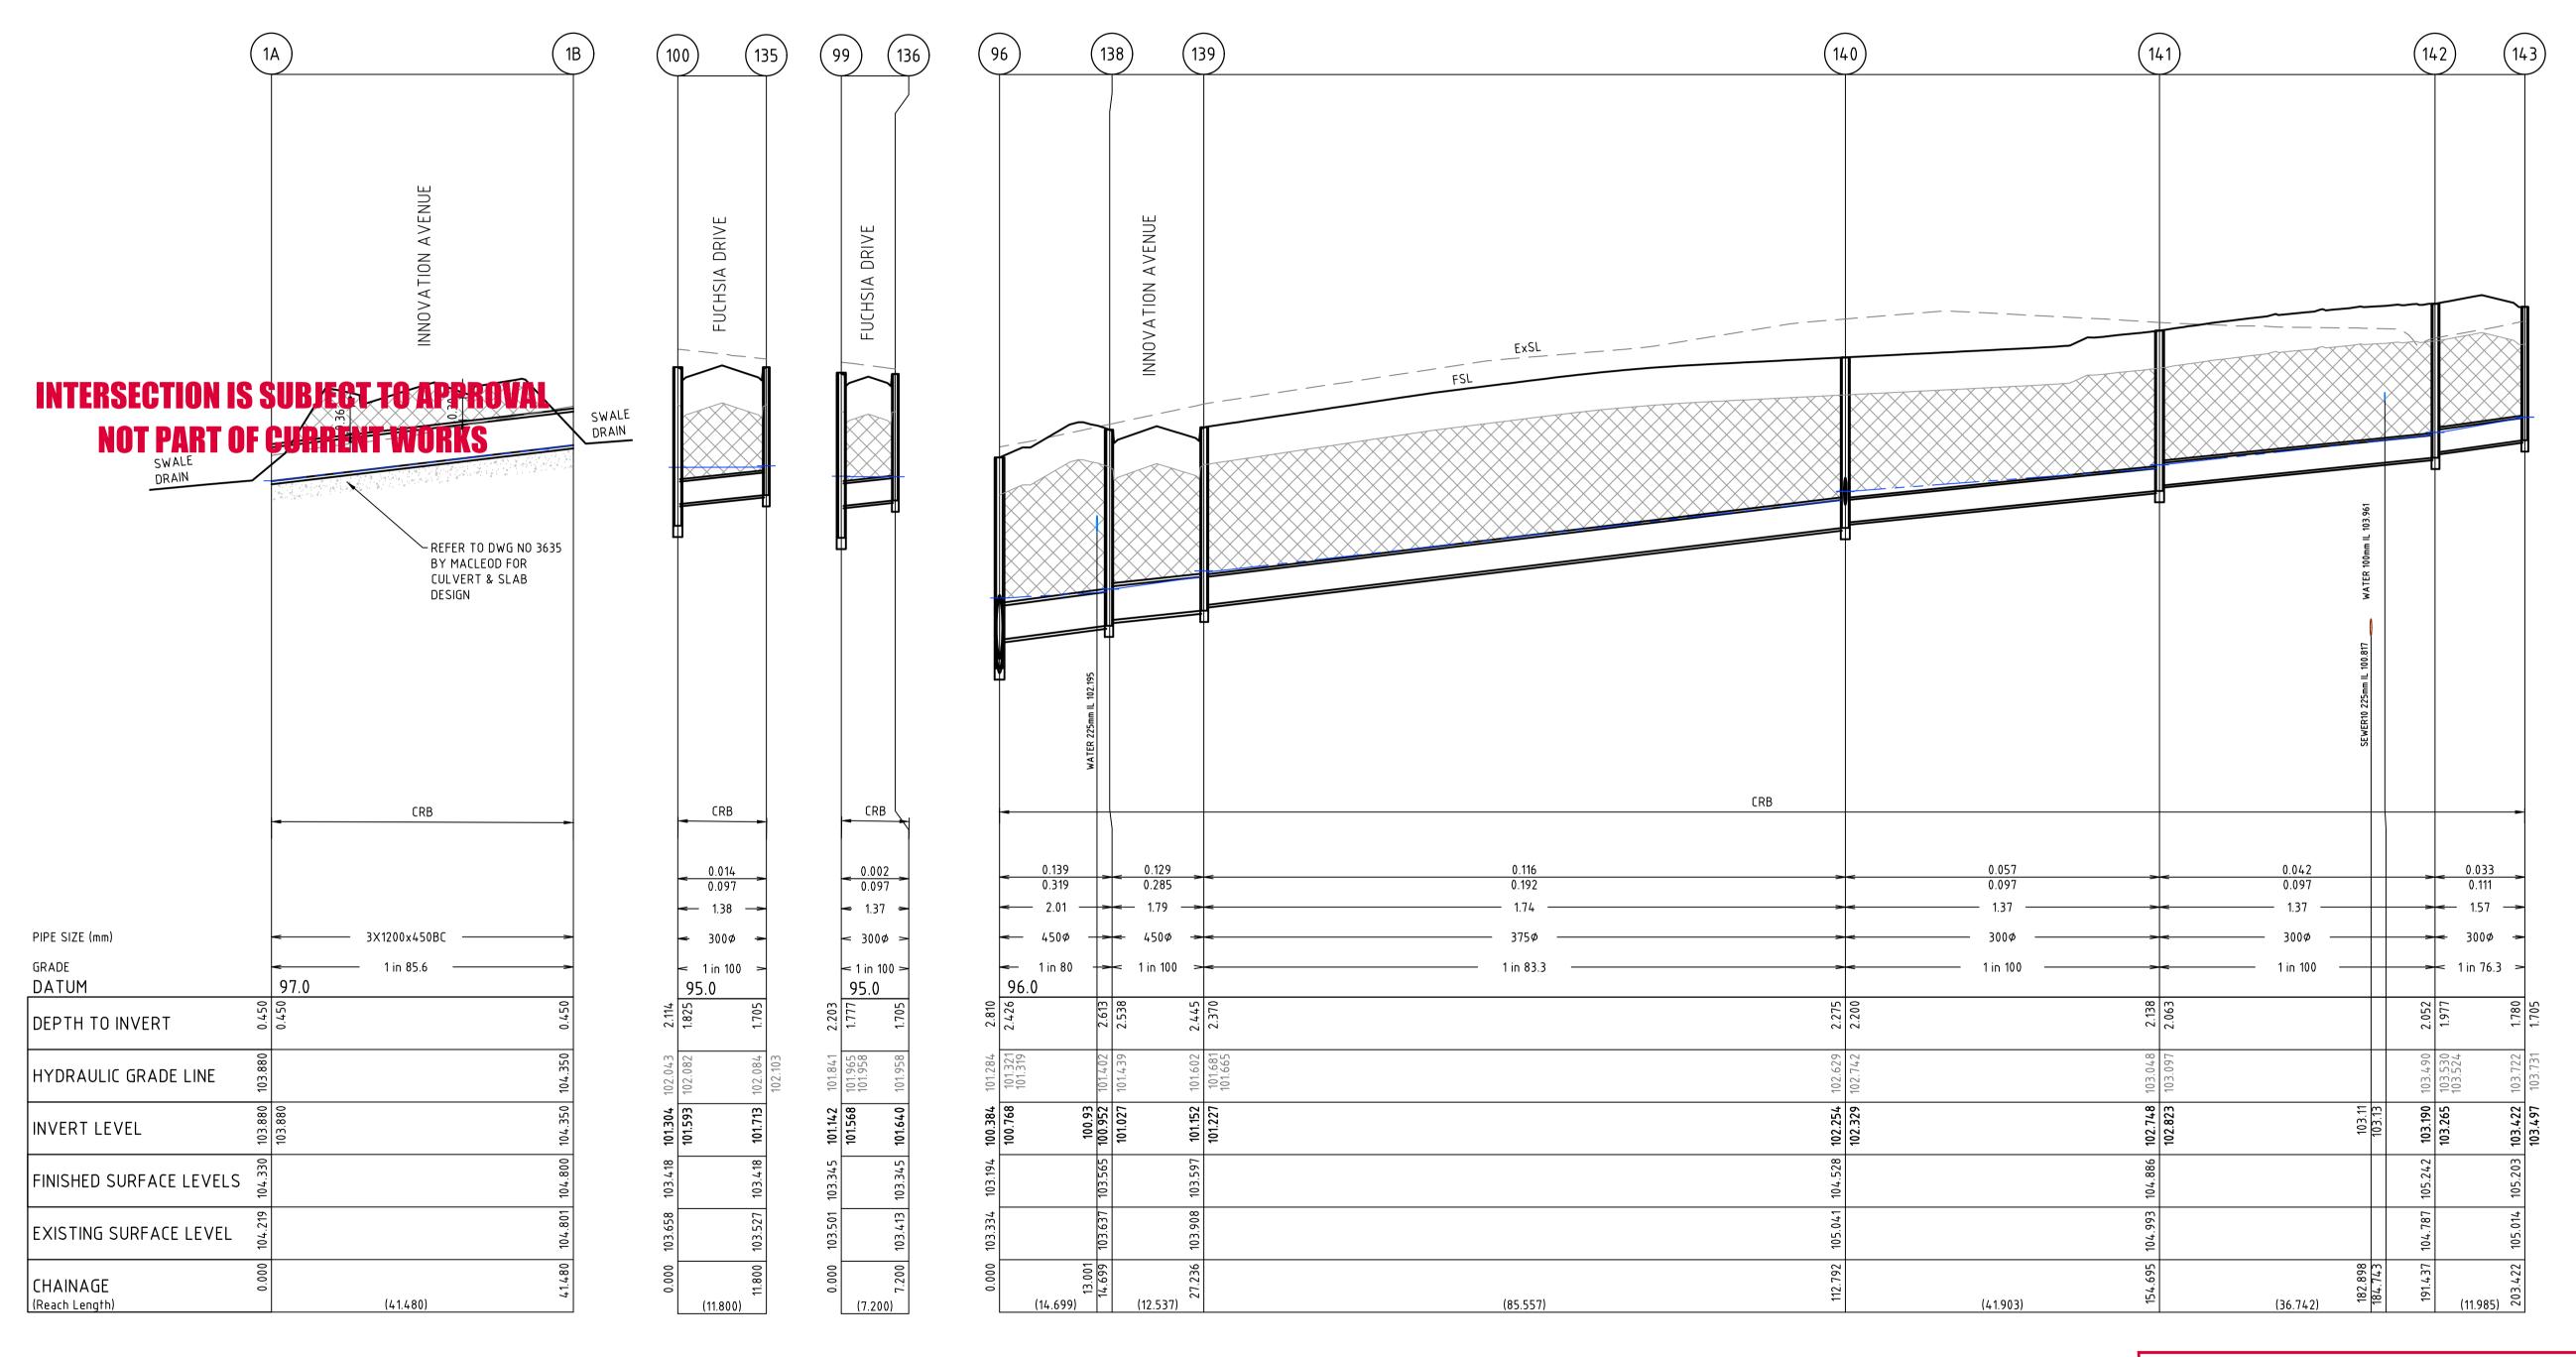

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13\CAD\DV	E	AS CONSTRUCTED	21.06.23	JZ
3\CA	D	DRAIN LONG SECTION UPDATED	18.07.22	JZ
AGE 13	С	CONSTRUCTION ISSUE	18.01.22	JZ
I:\22236\STA	В	LOT LAYOUT AMENDED, DRAIN AMENDED TO SUIT	06.08.21	JZ
	Α	PRELIMINARY ISSUE	23.03.2020	JZ
1:\2;	VERSION	REMARKS		

0	5	10	20
0	0.5	1	
Scal	0.0	500 V 1	:50 @ A1
		LONG	SECTION

DRAWN BY	N. KASHA	DESIGNED BY	J. ZHOU
MELWAY	344, K12	CHECKED BY	L. PHAN
DATUM	AHD	AUTHORISED BY	S. RAVIDA




LAND SURVEYING **CIVIL ENGINEERING PLANNING DEVELOPMENT CONSULTING**

CITY OF MELTON BRIDGEFIELD ESTATE, ROCKBANK STAGE 13 DRAINAGE LONGITUDINAL SECTIONS - 2

VERSION DRAWING No. 13R23 REFERENCE 22236E/13

 EXISTING SURFACE
 FINISHED SURFACE
 FUTURE SURFACE
 HYDRAULIC GRADE LINE
CLASS 3 FCR BACKFILL (REFER "DRAINAGE TRENCH BACKFILL" DETAIL BELOW).

		<i></i>	
		ExSL	
	•	FSL	
	Ī		
	١		
		CRB	-
DESIGN FLOW (m3/s) CAPACITY (m3/s)		0.032 0.097	
AT GRADE VELOCITY (m/s)		1.37	>
PIPE SIZE (mm)		⋖ 300¢ —	
GRADE	+	- 1 in 100	>
DATUM	0,	97.0 	7
DEPTH TO INVERT	1.780	1.705	1.554
	722	731	282
HYDRAULIC GRADE LINE	-	103.731	104.282
INVERT LEVEL	103.422	103.497	103.982
			
FINISHED SURFACE LEVELS	105.203		105.536
	ا ہے		(-)
EXISTING SURFACE LEVEL	105.014		105.778
EXISTING SURFACE LEVEL CHAINAGE	203.395 105.0		251.838 105.

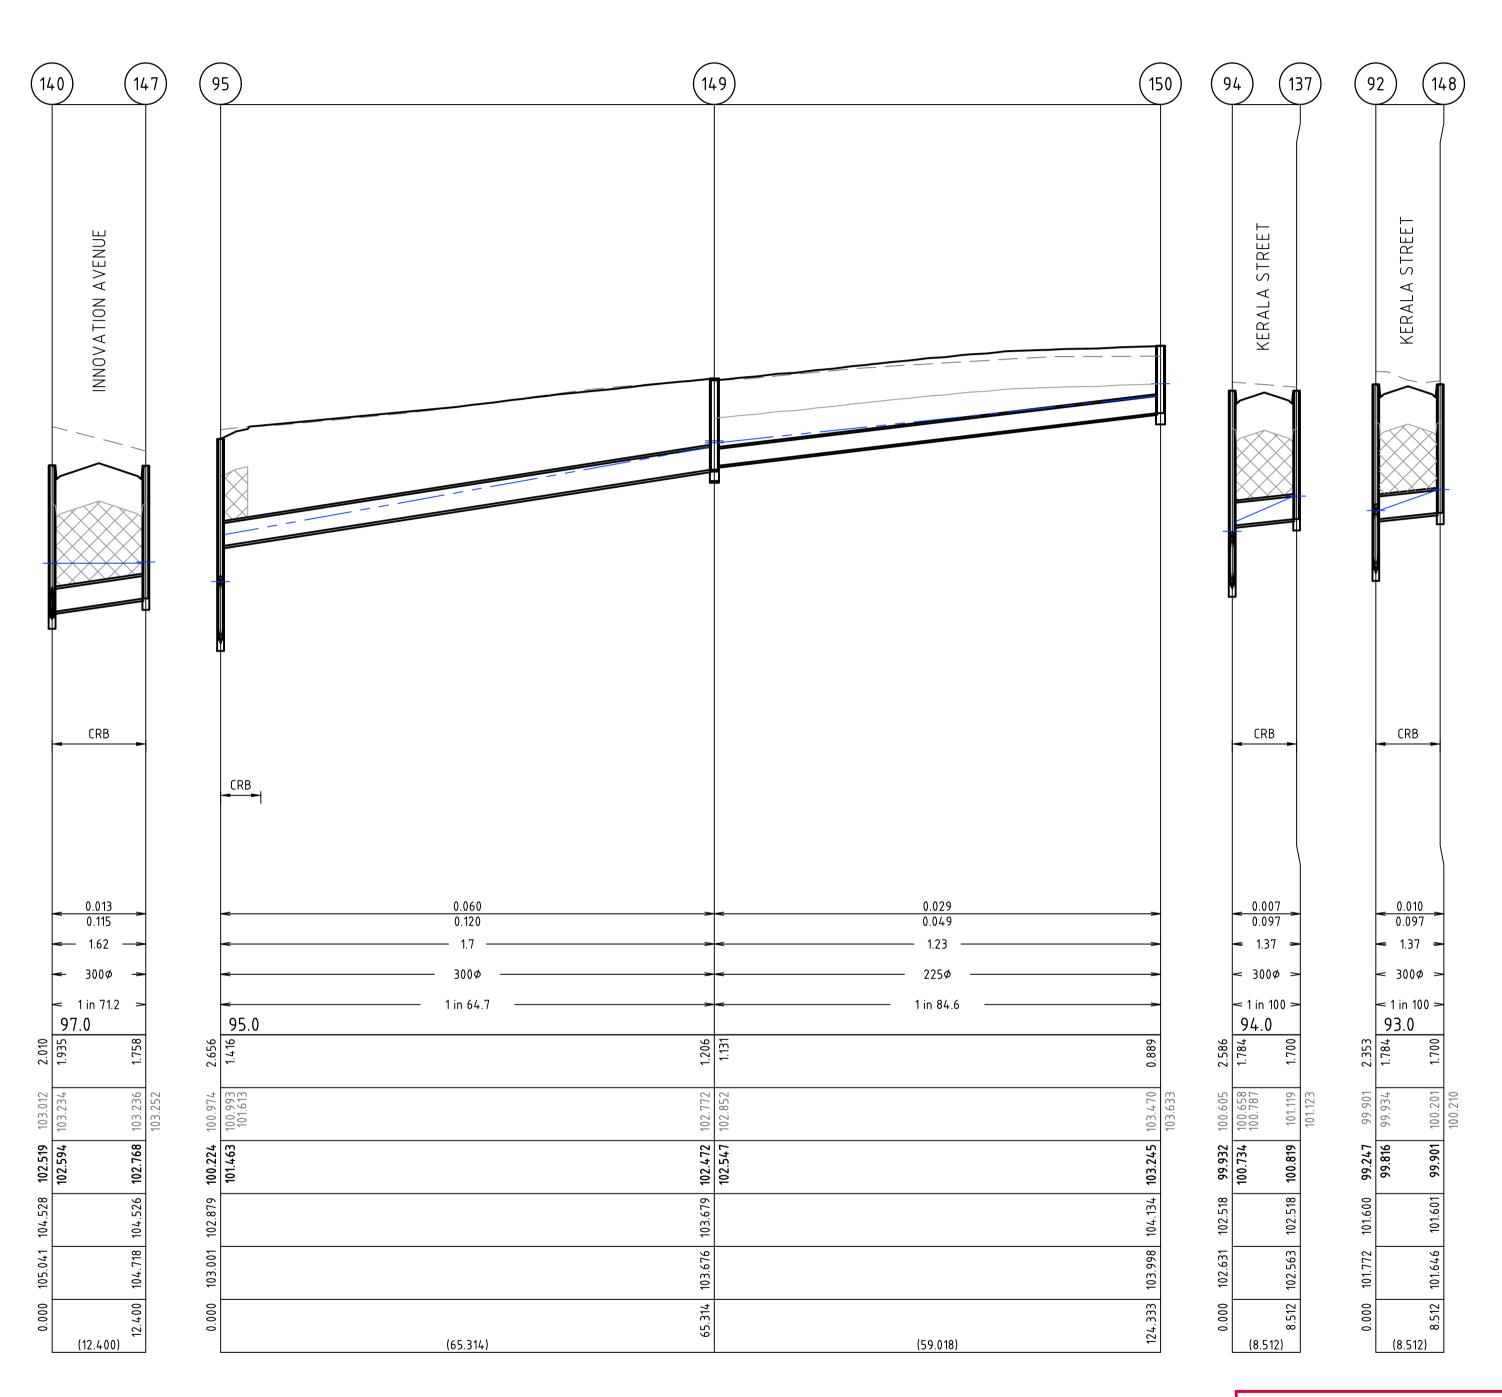

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AD\D				
3/CA	D	AS CONSTRUCTED	21.06.23	JZ
GE 1	С	CONSTRUCTION ISSUE	18.01.22	JZ
\S A	В	LOT LAYOUT AMENDED, DRAIN AMENDED TO SUIT	06.08.21	JZ
22236\	Α	PRELIMINARY ISSUE	23.03.2020	JZ
1:\7;	VERSION	REMARKS		

Scale H 1:500 V 1:50 @ A1 LONG SECTION DRAWN BY DESIGNED BY N. KASHA J. ZHOU CHECKED L. PHAN 344, K12 MELWAY UTHORISED S. RAVIDA DATUM AHD

LAND SURVEYING **CIVIL ENGINEERING** DEVELOPMENT CONSULTING

CITY OF MELTON BRIDGEFIELD ESTATE, ROCKBANK STAGE 13 DRAINAGE LONGITUDINAL SECTIONS - 3

VERSION DRAWING No. 13R24 REFERENCE

22236E/13 24 OF 36

LEGEND

———— EXISTING SURFACE

— FINISHED SURFACE

— — — HYDRAULIC GRADE LINE

FUTURE SURFACE

CLASS 3 FCR BACKFILL (REFER "DRAIN TRENCH BACKFILL" DETAIL BELOW).

CLASS 3 FCR BACKFILL (REFER "DRAINAGE

THIS DRA	THIS DRAWING IS NOT TO BE COPIED OR SCALED				
E	AS CONSTRUCTED				
D	DRAIN LEVELS AMENDED				

31.03.22 JZ C CONSTRUCTION ISSUE 18.01.22 JZ LOT LAYOUT AMENDED, DRAIN AMENDED TO SUIT 06.08.21 JZ PRELIMINARY ISSUE 23.03.2020 JZ REMARKS VERSION

DESIGN FLOW (m3/s) CAPACITY (m3/s)

PIPE SIZE (mm)

GRADE

DATUM

AT GRADE VELOCITY (m/s)

DEPTH TO INVERT

INVERT LEVEL

CHAINAGE

(Reach Length)

HYDRAULIC GRADE LINE

FINISHED SURFACE LEVELS

EXISTING SURFACE LEVEL

21.06.23 JZ

Scale H 1:500 V 1:50 @ A1 LONG SECTION

- 2.91 -> 1.59

= 1 in 29.8 🔫 1 in 100 🔫

100.380

(11.607)

375ø

95.0

CHECKED L. PHAN 344, K12 MELWAY UTHORISED S. RAVIDA DATUM AHD

(41.046)

CRB

1 in 150

(44.074)

LAND SURVEYING **CIVIL ENGINEERING PLANNING**

(52.816)

CITY OF MELTON BRIDGEFIELD ESTATE, ROCKBANK STAGE 13 DRAINAGE LONGITUDINAL SECTIONS - 4

(8.627)

THIS PLAN HAS BEEN PREPARED TO REFLECT THE WORKS AS PRESENTED AT END OF SUBDIVISION CONSTRUCTION. THE PLAN IS NOT BASED ON SURVEY OF THE COMPLETED WORKS. ALL LEVELS, CO-ORDINATES AND SERVICE LOCATIONS SHOWN ON THE PLANS ARE THE DESIGN INFORMATION AND SHOULD NOT BE RELIED UPON BY ANY FUTURE PARTY IN RELATION TO DETAILED DESIGN ACTIVITIES. THESE PLANS ARE PROVIDED TO COUNCIL FOR ASSET MANAGEMENT PURPOSES AND ANY USE OF THE PLANS BY THIRD PARTIES IS NOT PERMITTED. ANY SUBSEQUENT DESIGN OR CONSTRUCTION ACTIVITIES IN THE AREA DEFINED ON THESE PLANS WILL REQUIRE ADDITIONAL SITE SURVEY AND ASSET PROVING BY THE RELEVANT PARTY.

> VERSION DRAWING No. 13R25 REFERENCE 22236E/13

25 OF 36

DESIGNED DRAWN N. KASHA J. ZHOU


(67.040)

(153)

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CLASS 3 FCR BACKFILL (REFER "DRAINAGE TRENCH BACKFILL" DETAIL BELOW).

	163)		164		165	(10	56)	(167	7) (168)
			CRB				SEWER10 225mm IL 98.921	WATER 100mm IL 102.009	
DESIGN FLOW (m3/s) CAPACITY (m3/s) AT GRADE VELOCITY (m/s) PIPE SIZE (mm) GRADE DATUM	94.0	0.099 0.147 — 1.33 — 375¢ 1 in 143	> <	0.054 0.092 — 1.31 300¢ — 1 in 110	>	3007	- 30	70 99 00	0.006 0.109 1.54 300\$\phi\$
	1.629		1.797		1.692	1.722	1.647	1.833	1.646
HYDRAULIC GRADE LINE	100.560		101.032		101.422 101.490 101.485	101.590	101.591	101.725	101.885
	100.194		100.584		101.122			101.425	
	101.823		102.381 1		102.889	103.012	,	103.258	103.231
	101.988		102.550		102.864 1	102.883		102.946 1	102.957
	36.024	(55.798)	91.822	(50.818)	142.640 1	(17.314)	<u>=</u> 65.338		(6.699)

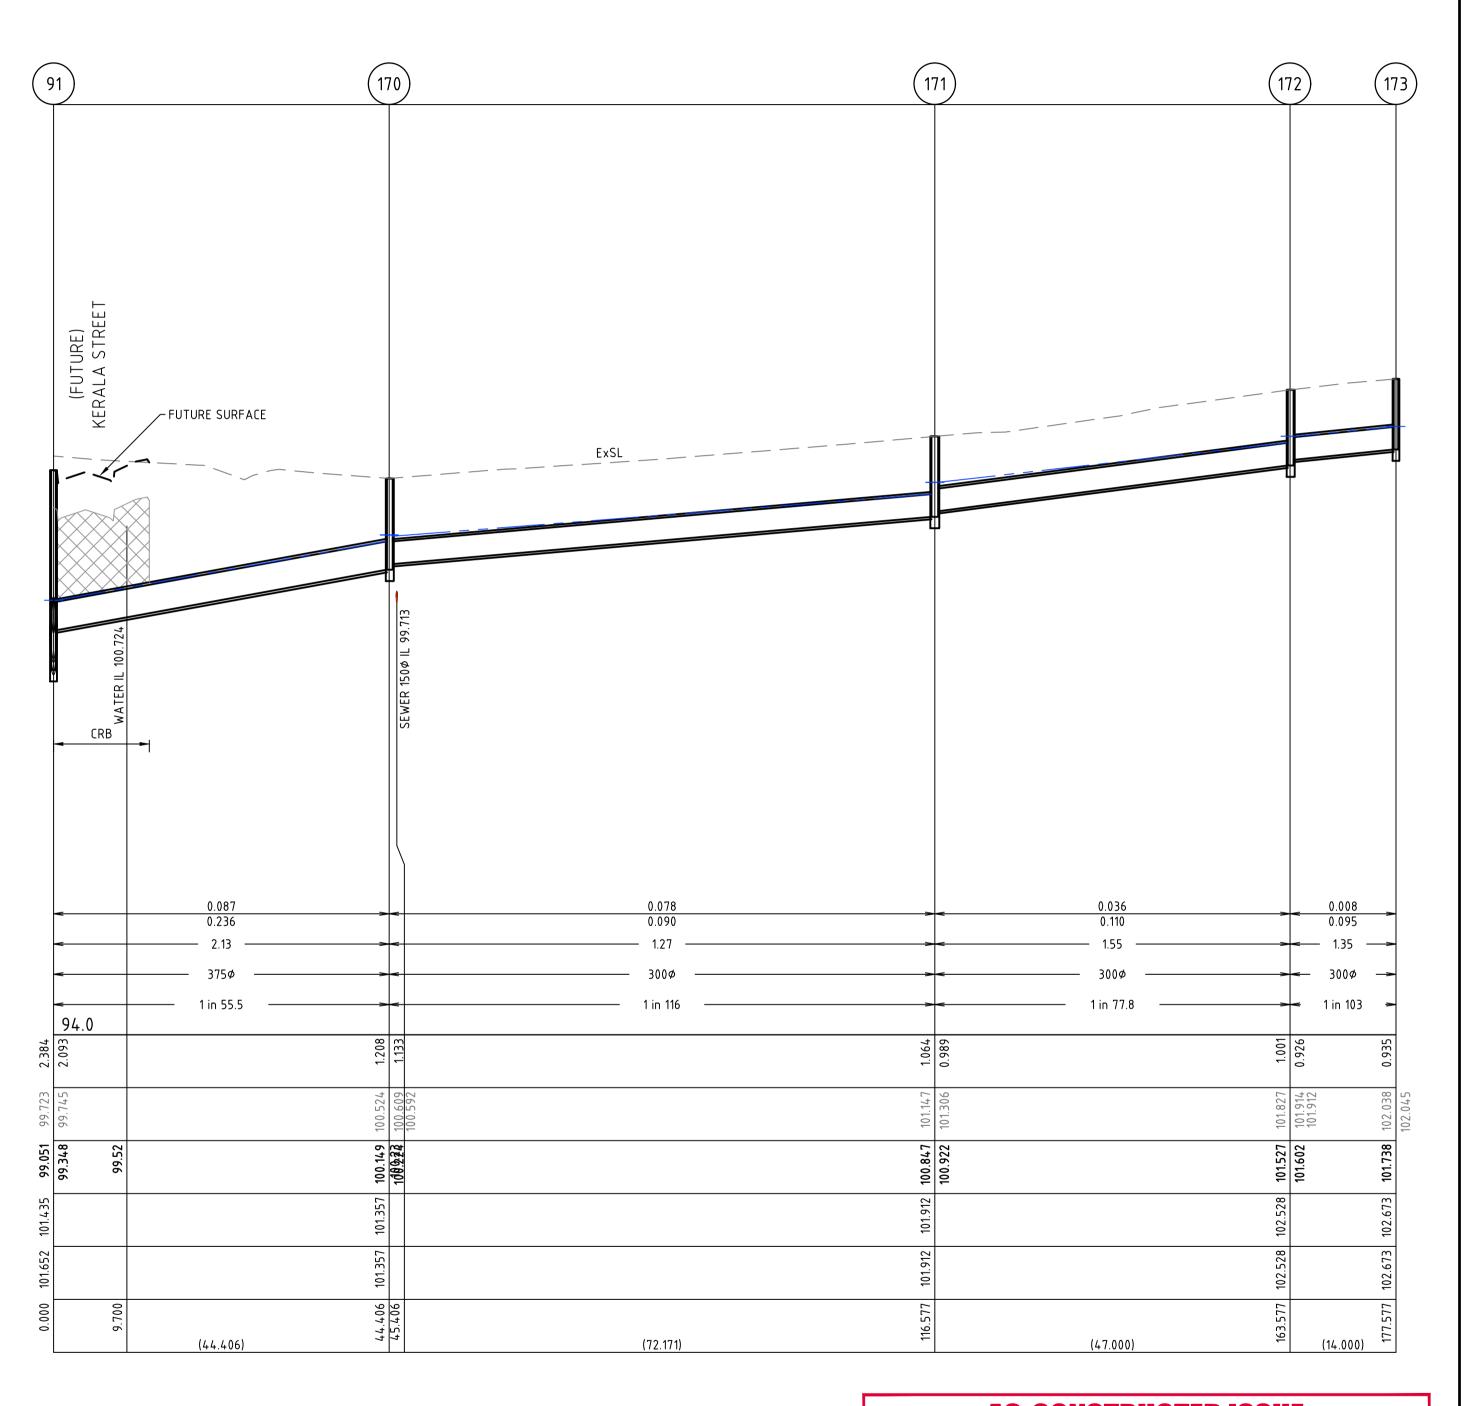

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0/0				
13\CAD\D\	D	AS CONSTRUCTED	21.06.23	JZ
AGE 1.	С	CONSTRUCTION ISSUE	18.01.22	JZ
ST	В	LOT LAYOUT AMENDED, DRAIN AMENDED TO SUIT	06.08.21	JZ
22236\	Α	PRELIMINARY ISSUE	23.03.2020	JZ
1:\2	VERSION	REMARKS		

)	5 1	0	20
0	.5	1	2
cale l	1:500) V 1:50 @	A1
	LC	NG SECTI	ON

DRAWN BY	N. KASHA	DESIGNED BY	J. ZHOU
MELWAY	344, K12	CHECKED BY	L. PHAN
DATUM	AHD	AUTHORISED BY	S. RAVIDA



LAND SURVEYING **CIVIL ENGINEERING PLANNING** DEVELOPMENT CONSULTING


CITY OF MELTON BRIDGEFIELD ESTATE, ROCKBANK STAGE 13 DRAINAGE LONGITUDINAL SECTIONS - 5

VERSION DRAWING No. 13R26 REFERENCE

22236E/13 26 OF 36

PIT SCHEDULE

					PI.	T SCHEDULE			_			<u> </u>
PIT NUMBER	TYPE	INTERNAL	LENGTH (mm)	INLET	INVERT R.L.(m)	OUTLET	INVERT R.L. (m)	F.S.L. (m)	DEPTH (m)	STANDARD DRAWING	REMARKS	
1A	ENDWALL	WIDTH (mm)		3X1200X450	103.88	DIAMETER (mm)				SD1971/1972	<u> </u>	-
1B	ENDWALL			3X1200X430	103.88	3X1200X450	104.350			SD1971/1972		1
90	JUNCTION PIT	12		TIONI				0.300	2.443	EDCM 605/607	TO BE HAUNCHED UNDER FUT. KERB	1
91	JUNCTION PIT	120	Ember	GIIBN I	S SUBJ	900	9 0 1	(£)0 (1 1 1	2.390	EDCM 605/607	TO BE HAUNCHED UNDER FUT. KERB	1
				375	99.348]
			NOT	DART	JE CHDE	DENT IM	NDVC					
92	SIDE ENTRY PIT GRATED	1200			<u> Jr Guni</u>		UBA	101.600	2.353	EDCM 601/607	CONVERT Ex. JP TO SEPG	_
				300	99.816							_
93	JUNCTION PIT	1200	900	900	99.581	900	99.531	102.166	2.636	EDCM 605/607	TO BE HAUNCHED UNDER KERB	-
0.4	CIDE ENTRY RIT CRATER	1200	000	375	99.990 99.882	000	00.022	102.510	2.505	EDCN 601/607	CONNECT For ID TO CEDG	-
94	SIDE ENTRY PIT GRATED	1200	900	900 300	100.734	900	99.832	102.518	2.686	EDCM 601/607	CONVERT Ex. JP TO SEPG	-
95	SIDE ENTRY PIT GRATED	1200	900	900	100.734	900	100.124	102.879	2.756	EDCM 601/607	CONVERT Ex. JP TO SEPG	1
	SIDE ENTRIPH GIVIED	1200	300	300	101.463	300	100.12-	102.075	2.730	EDCIVI 001/007	CONVENTEX.31 TO SET G	1
96	SIDE ENTRY PIT GRATED	1200	1200	750	100.559	900	100.384	103.194	2.810	EDCM 601/607	CONVERT Ex. JP TO SEPG	1
				450	100.768]
97	SIDE ENTRY PIT GRATED	900	1200	750	100.809	750	100.759	103.200	2.441	EDCM 601/607	CONVERT Ex. JP TO SEPG	
98	SIDE ENTRY PIT GRATED	900	1200	750	100.962	750	100.912	103.152	2.240	EDCM 601/607	CONVERT Ex. JP TO SEPG	_
99	DOUBLE SIDE ENTRY PIT GRATED	1200	900	750	101.192	750	101.142	103.345	2.203	EDCM 602/607	CONVERT Ex. JP TO DSEPG	-
100	501915 0195 51797 017 09 1759	1000		300	101.568	750	404.004	400.440	0.111	5001 C00 (507	00111/507.5 ID TO DOSDO	-
100	DOUBLE SIDE ENTRY PIT GRATED	1200	900	525	101.518	750	101.304	103.418	2.114	EDCM 602/607	CONVERT Ex. JP TO DSEPG	-
				300	101.593							-
135	DOUBLE SIDE ENTRY PIT GRATED	600	900			300	101.713	103.418	1.705	EDCM 602		1
136	DOUBLE SIDE ENTRY PIT GRATED	600	900		-	300	101.640	103.345	1.705	EDCM 602		1
137	DOUBLE SIDE ENTRY PIT GRATED	600	900			300	100.819	102.518	1.700	EDCM 602		1
138	SIDE ENTRY PIT GRATED	900	900	450	101.027	450	100.952	103.565	2.613	EDCM 601	TO BE HAUNCHED UNDER KERB]
139	DOUBLE SIDE ENTRY PIT GRATED	600	900	375	101.227	450	101.152	103.597	2.445	EDCM 602		
140	DOUBLE SIDE ENTRY PIT GRATED	600	900	300	102.329	375	102.254	104.528	2.275	EDCM 602		
				300	102.594							-
141	JUNCTION PIT	600	900	300	102.823	300	102.748	104.886	2.138	EDCM 605		-
1.42	HINCTION DIT	600	000	200	102.265	300	103 100	105 242	2.052	EDCM 605		-
142 143	JUNCTION PIT GRATED PIT	600 600	900 900	300 300	103.265 103.497	300 300	103.190 103.422	105.242 105.203	2.052 1.780	EDCM 605	HEAVY DUTY GRATED COVER	-
144	GRATED PIT	600	900	300	103.497	300	103.422	105.536	1.554	EDCM 605	HEAVY DUTY GRATED COVER	1
145	GRATED PIT	600	900	300	103.607	300	103.532	105.131	1.599	EDCM 605	HEAVY DUTY GRATED COVER	REMOVED
146	GRATED PIT	600	900			300	104.010	105.548	1.538	EDCM 605	HEAVY DUTY GRATED COVER	REMOVED
147	SIDE ENTRY PIT GRATED	600	900			300	102.768	104.526	1.758	EDCM 601]
148	DOUBLE SIDE ENTRY PIT GRATED	600	900			300	99.901	101.601	1.700	EDCM 602		
149	JUNCTION PIT	600	900	225	102.547	300	102.472	103.679	1.206	EDCM 605		
150	JUNCTION PIT	600	900			225	103.245	104.134	0.889	EDCM 605		_
151	SIDE ENTRY PIT GRATED	600	900	375	100.455	375	100.380	102.343	1.963	EDCM 601		-
152	SIDE ENTRY PIT GRATED	600	900	375	100.613	375	100.538	102.415	1.877	EDCM 601		-
153	SIDE ENTRY PIT GRATED	600	900	300 300	101.135 101.135	375	101.060	102.920	1.859	EDCM 601		-
154	JUNCTION PIT	600	900	300	101.620	300	101.545	103.248	1.703	EDCM 605		1
154	JONETIONTTI	555	500	300	101.020	300	101.545	103.240	1.703	EDCIVI 003		1
155	GRATED PIT	600	900	300	101.990	300	101.915	103.657	1.742	EDCM 605	HEAVY DUTY GRATED COVER	1
156	GRATED PIT	600	900	300	102.097	300	102.022	103.641	1.619	EDCM 605	GRATED COVER	REMOVED
157	GRATED PIT	600	900			300	103.065	104.669	1.605	EDCM 605	HEAVY DUTY GRATED COVER	
158	GRATED PIT	600	900	300	101.975	300	101.900	103.529	1.628	EDCM 605	HEAVY DUTY GRATED COVER	REMOVED
159	GRATED PIT	600	900			300	102.486	104.043	1.556	EDCM 605	HEAVY DUTY GRATED COVER	REMOVED
160	SIDE ENTRY PIT GRATED	600	900	275	00.000	300	101.220	102.920	1.699	EDCM 601	FUTGERG	-
161 162	JUNCTION PIT JUNCTION PIT	600 600	900 900	375 375	99.809 99.970	375 375	99.734 99.895	101.610 101.674	1.877 1.779	EDCM 605 EDCM 605	FUT SEPG FUT SEPG	-
163	JUNCTION PIT	600	900	375	100.194	375	100.119	101.874	1.704	EDCM 605	FOT SEPG	-
103	JONETION FIT	000	300	300	100.134	373	100.119	101.823	1.704	EDCIVI 003		1
164	JUNCTION PIT	600	900	300	100.659	375	100.584	102.381	1.797	EDCM 605	FUT SEPG	1
				300	100.659							1
165	JUNCTION PIT	600	900	300	101.197	300	101.122	102.889	1.767	EDCM 605]
				225	101.614]
170	JUNCTION PIT	600	900	300	100.224	375	100.149	101.357	1.208	EDCM 605		
171	JUNCTION PIT	600	900	300	100.922	300	100.847	101.912	1.064	EDCM 605		
172	JUNCTION PIT	600	900	300	101.602	300	101.527	102.528	1.001	EDCM 605		_
173	JUNCTION PIT	600	900			300	101.738	102.673	0.935	EDCM 605		-
174	JUNCTION PIT	600	900	225	100.993	300	100.918	102.263	1.345	EDCM 605		-
175	JUNCTION PIT	600	900	225	101.797	225	101.722	102.749	1.027	EDCM 605		-
176 177	JUNCTION PIT GRATED PIT	600 600	900	300	101.413	225 300	102.261 101.338	103.115 102.848	0.853 1.510	EDCM 605 EDCM 605	HEAVY DUTY GRATED COVER	REMOVED
178	JUNCTION PIT	600	900	300	101.413	225	102.442	103.293	0.851	EDCM 605	HEAVY BOTT GIVATED COVER	KENOVED
170	JONETIONTTI	000	300			223	102.442	103.233	0.831	EDCIVI 003		_

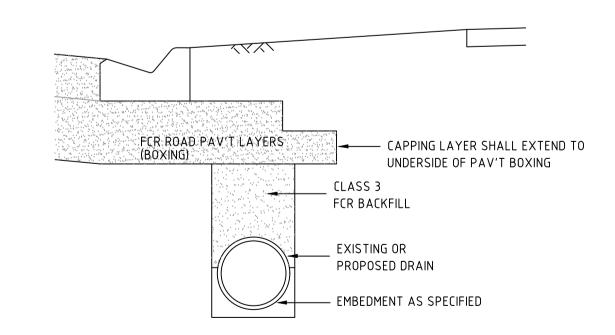

DRAINAGE TRENCH BACKFILL TYPICAL DETAIL NOT TO SCALE

PIT SCHEDULE NOTES

1. EASTING AND NORTHING REFER TO CENTRE OF BASE OF PIT UNLESS NOTED OTHERWISE. 2."FIN RL" REFERS TO FINISHED LEVEL OF PIT LID AT CENTRE OF LID UNLESS NOTED OTHERWISE. 3. "LEN" = LENGTH OF PIT AND REFERS TO THE (INTERNAL) DIMENSION PARALLEL TO BACK OF KERB, UNLESS NOTED OTHERWISE. 4. "STD DWG" REFERS TO MPA AND MELBOURNE WATER STANDARD DRAWINGS UNLESS NOTED OTHERWISE.

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21.06.23 JZ E AS CONSTRUCTED DRAIN LEVELS AMENDED 31.03.22 JZ CONSTRUCTION ISSUE 18.01.22 JZ LOT LAYOUT AMENDED, DRAIN AMENDED TO SUIT 06.08.21 JZ PRELIMINARY ISSUE 23.03.2020 JZ VERSION REMARKS

——— EXISTING SURFACE

FINISHED SURFACE

FUTURE SURFACE

HYDRAULIC GRADE LINE

CLASS 3 FCR BACKFILL (REFER "DRAINAGE

TRENCH BACKFILL" DETAIL BELOW).

Scale H 1:500 V 1:50 @ A1 LONG SECTION DRAWN BY DESIGNED N. KASHA J. ZHOU CHECKED L. PHAN 344, K12 MELWAY UTHORISED S. RAVIDA DATUM AHD

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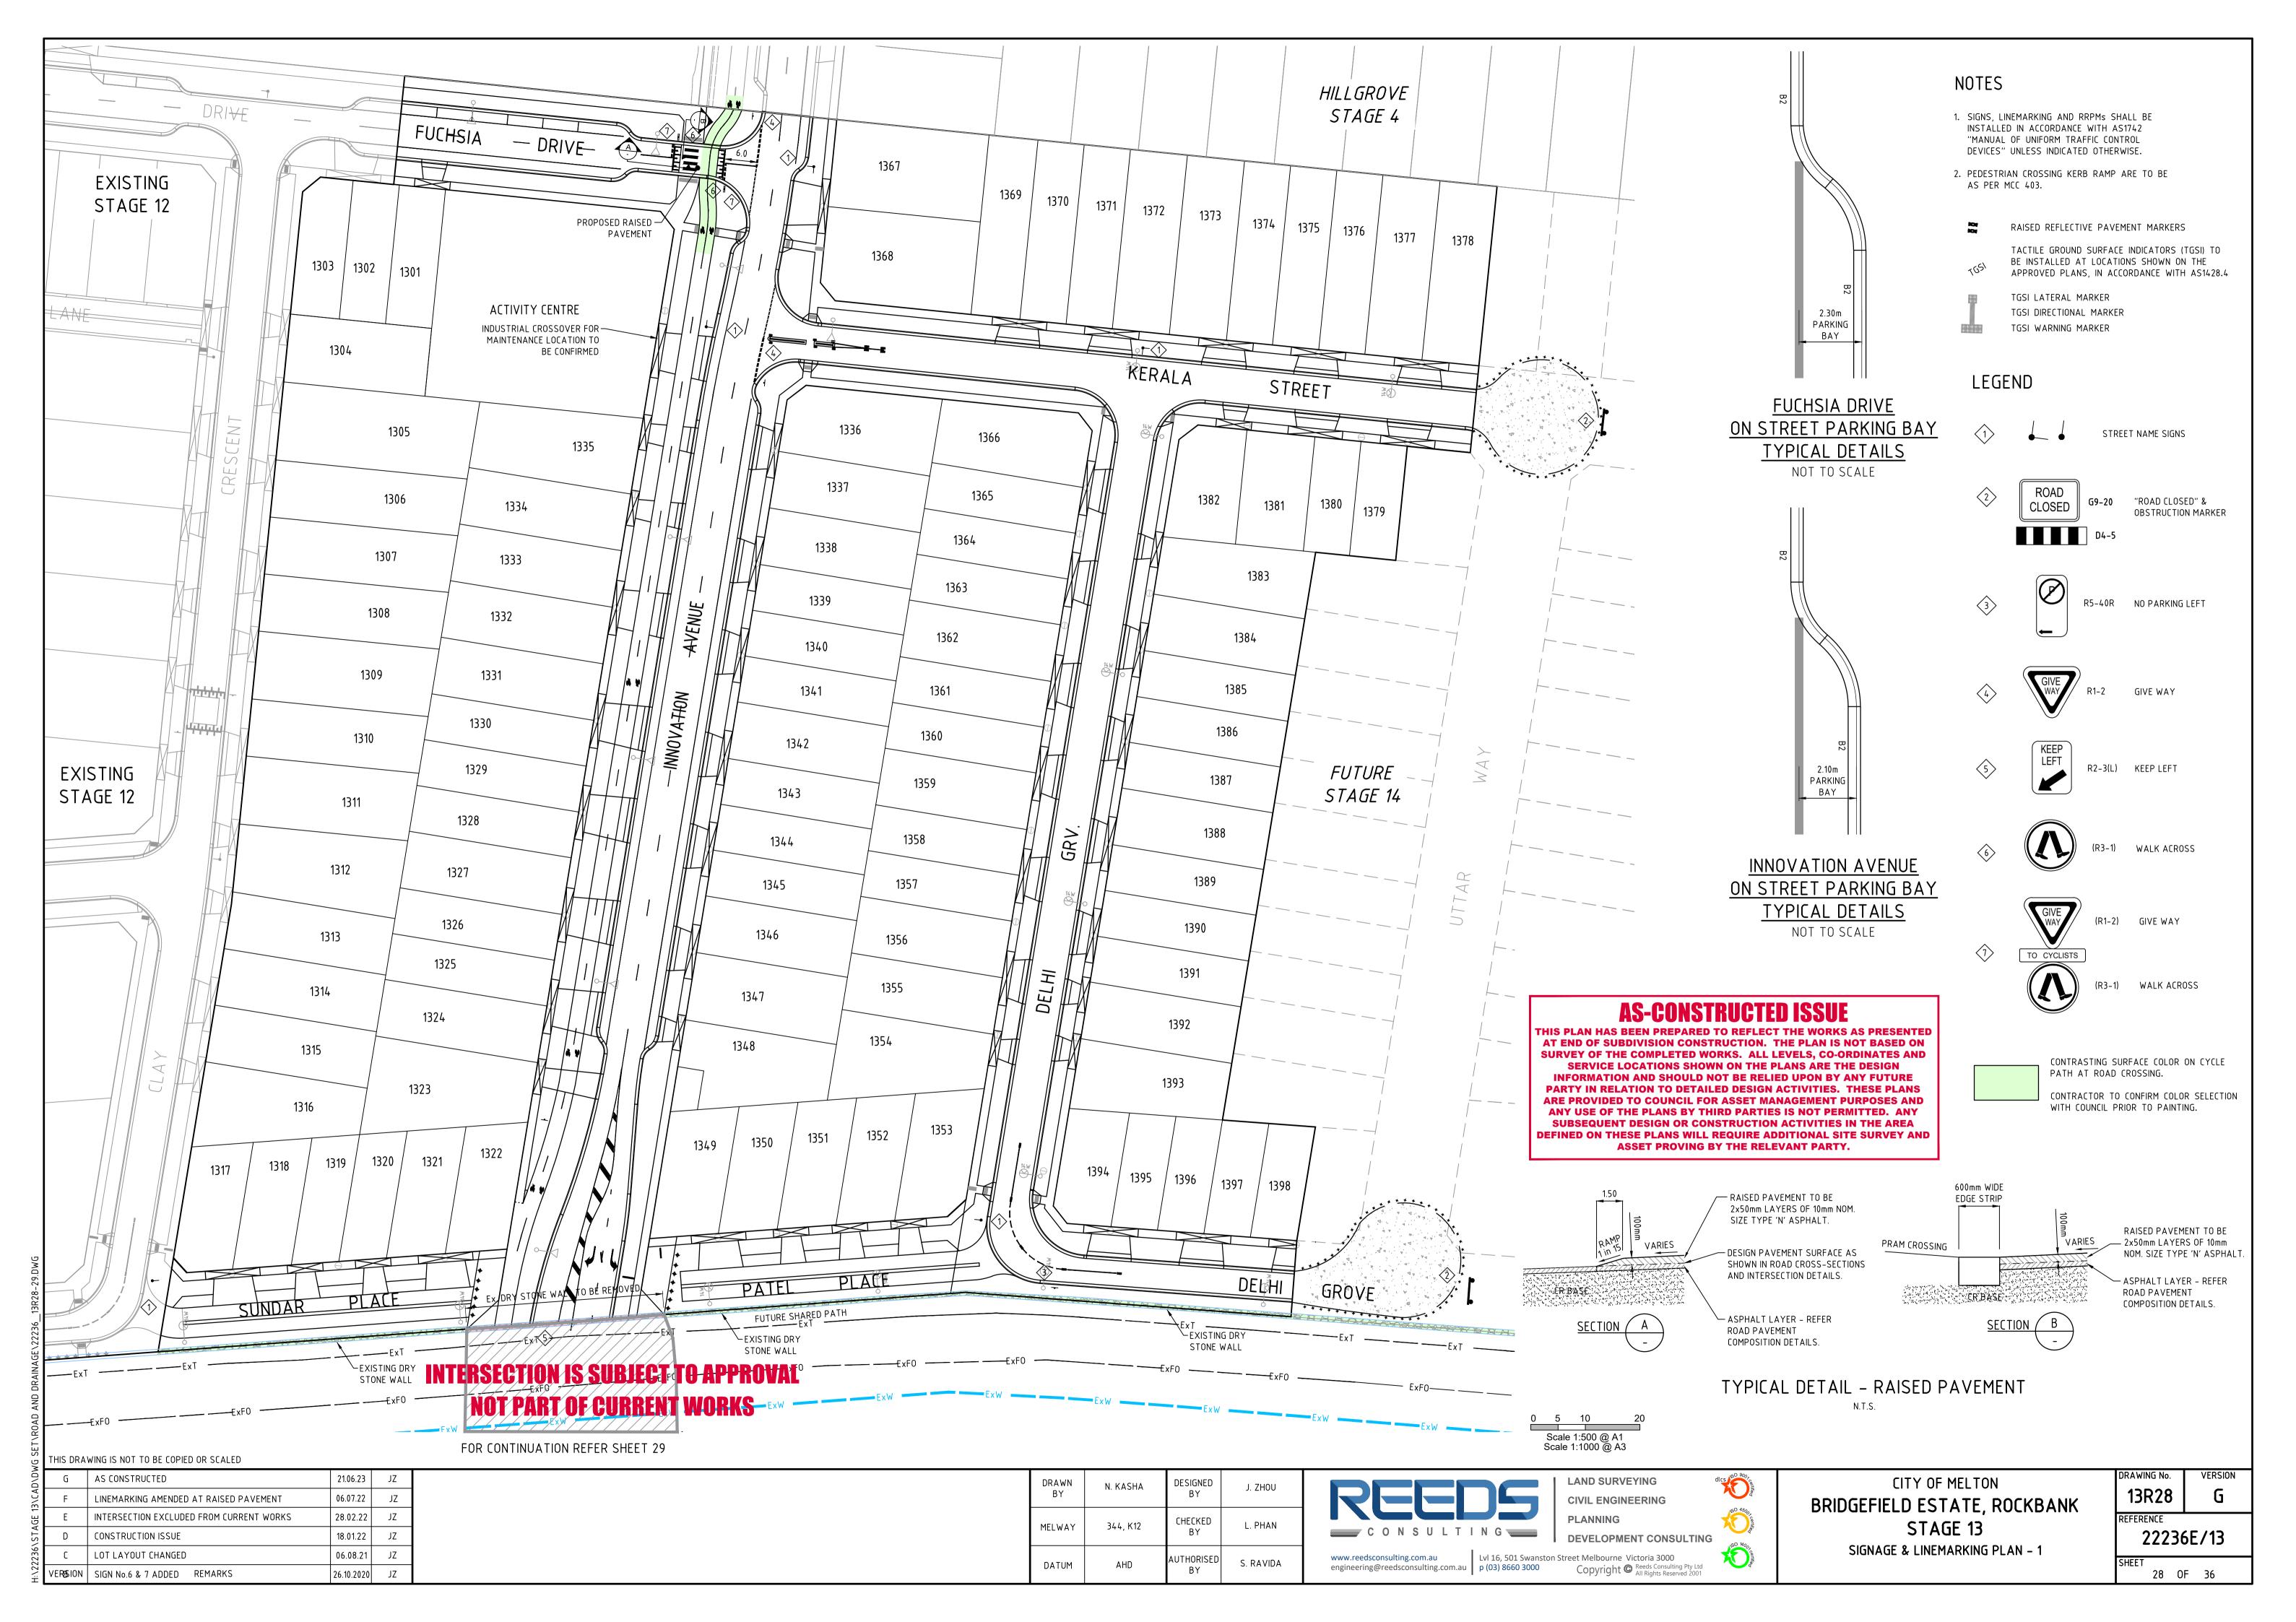
LAND SURVEYING **CIVIL ENGINEERING**


DEVELOPMENT CONSULTING


CITY OF MELTON BRIDGEFIELD ESTATE, ROCKBANK STAGE 13 DRAINAGE LONGITUDINAL SECTIONS - 6


AND PIT SCHEDULE

VERSION DRAWING No. 13R27 REFERENCE 22236E/13



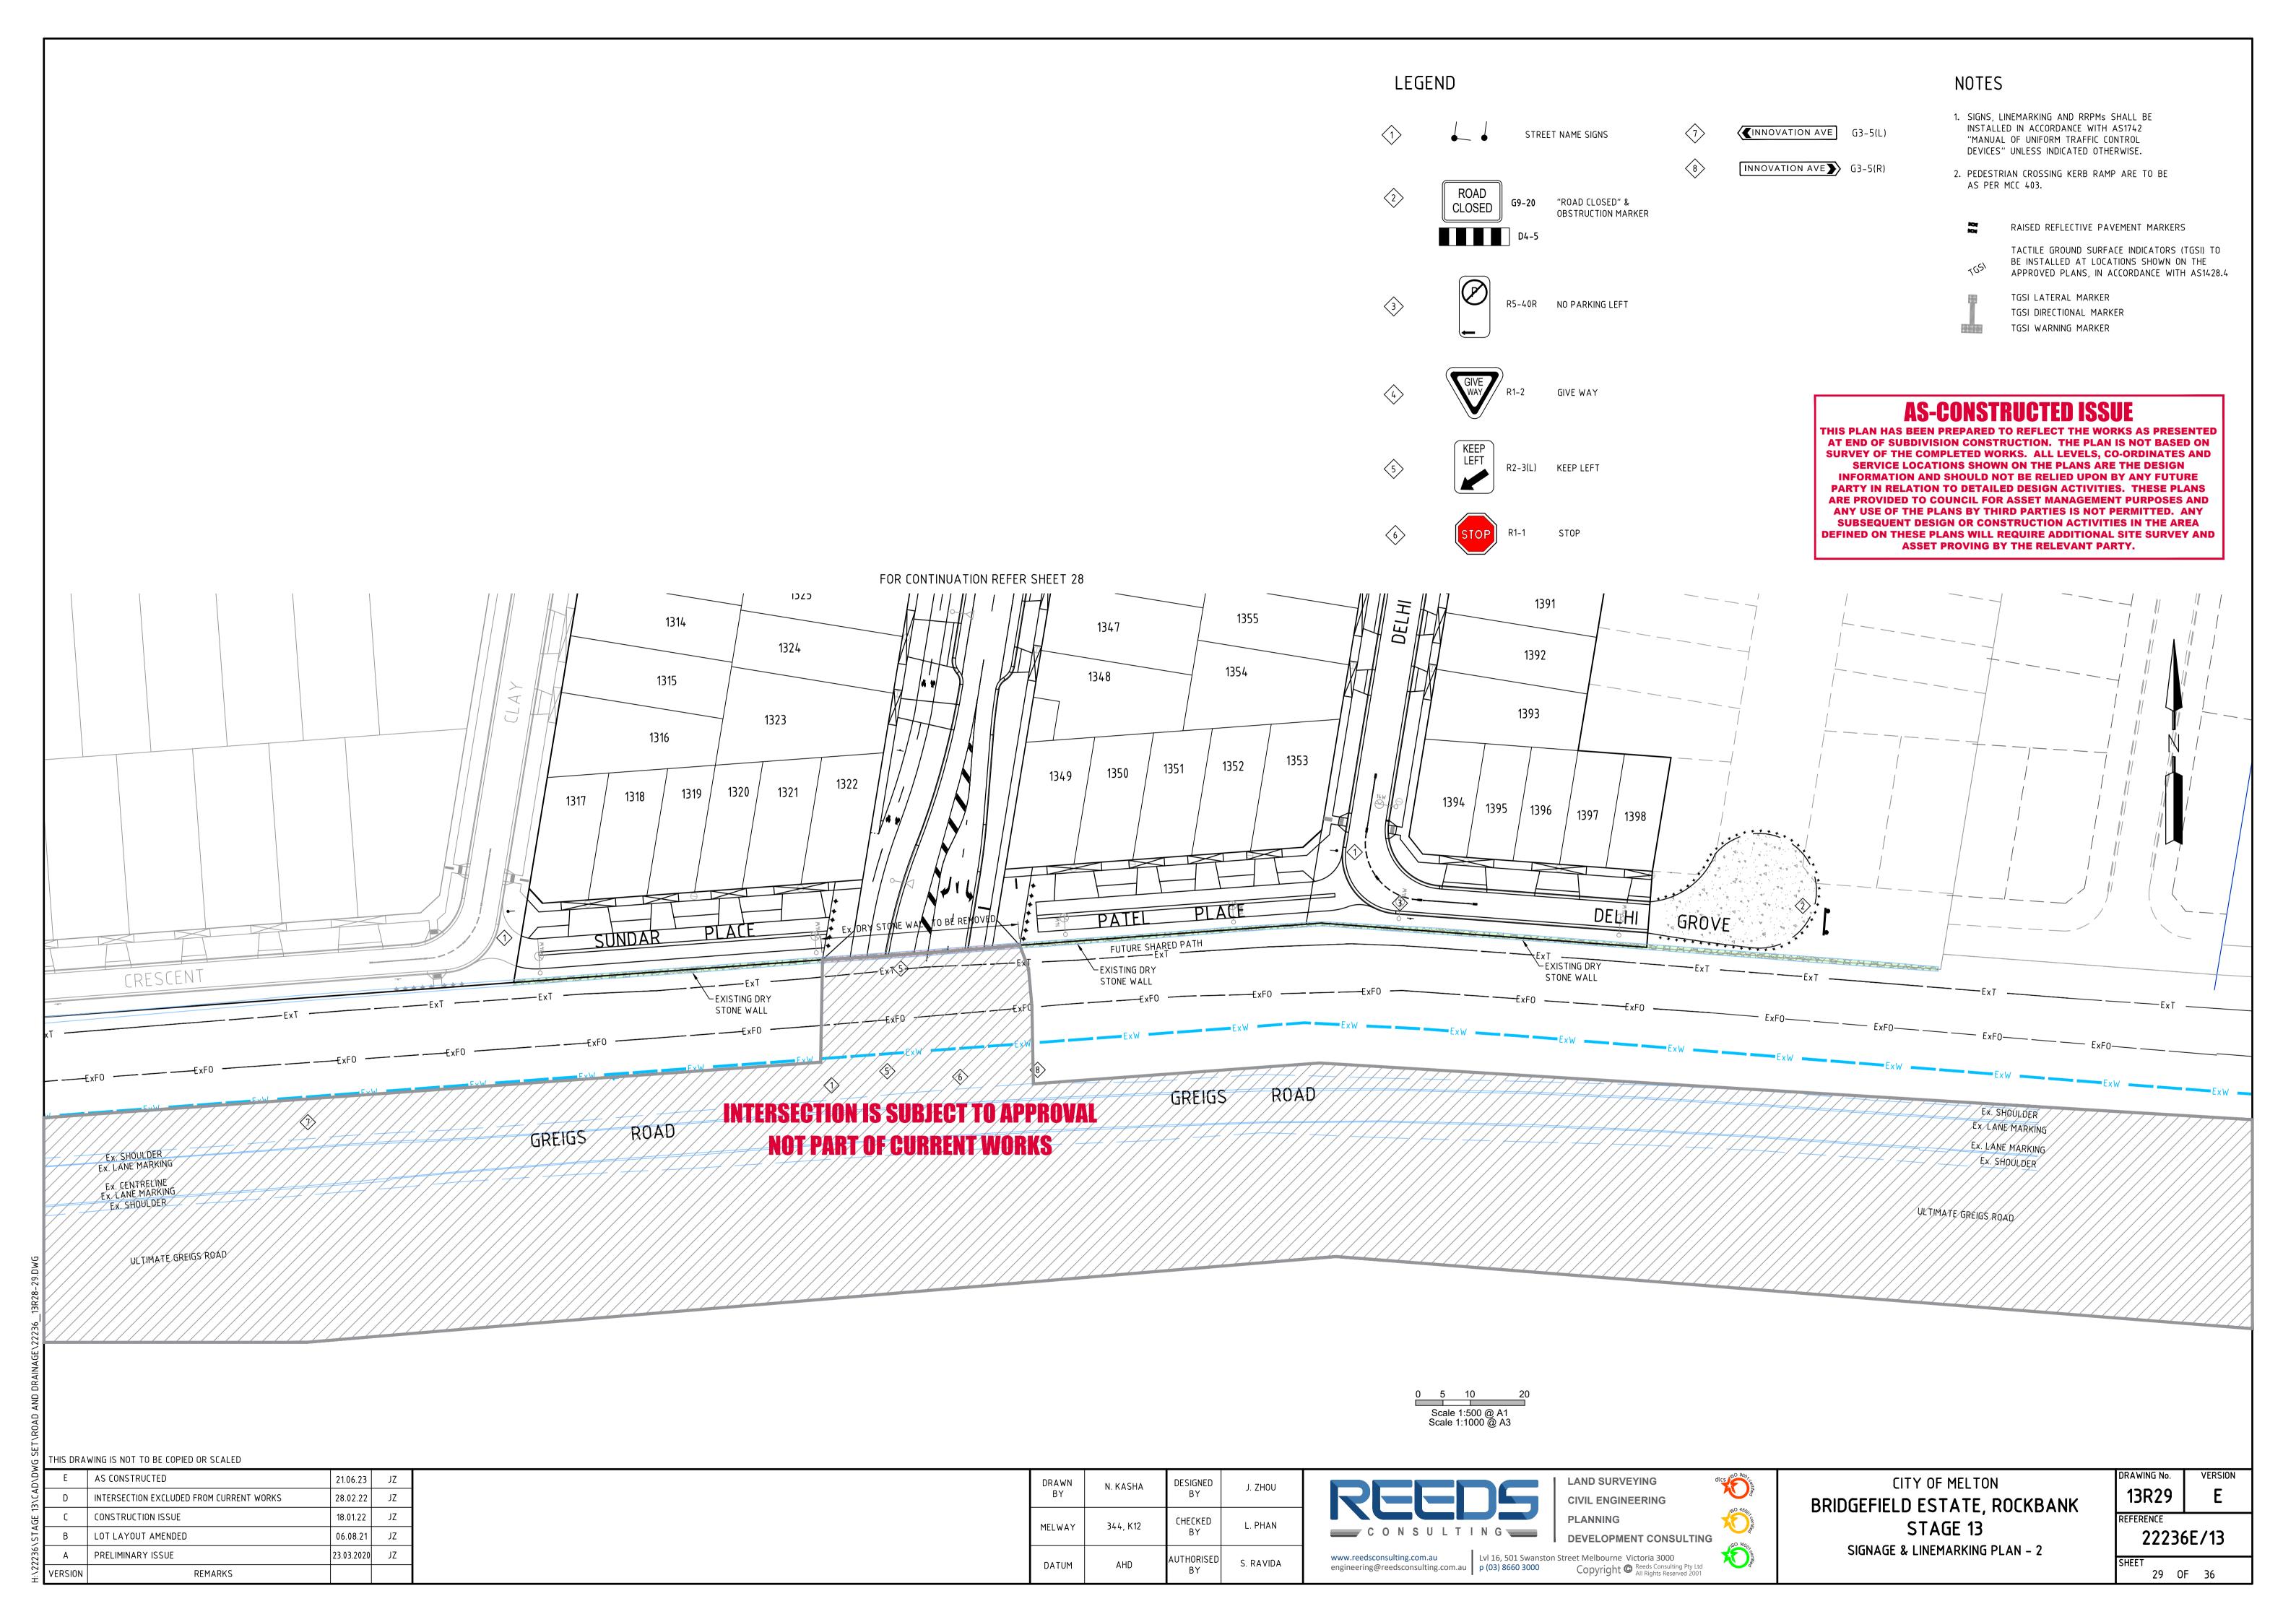

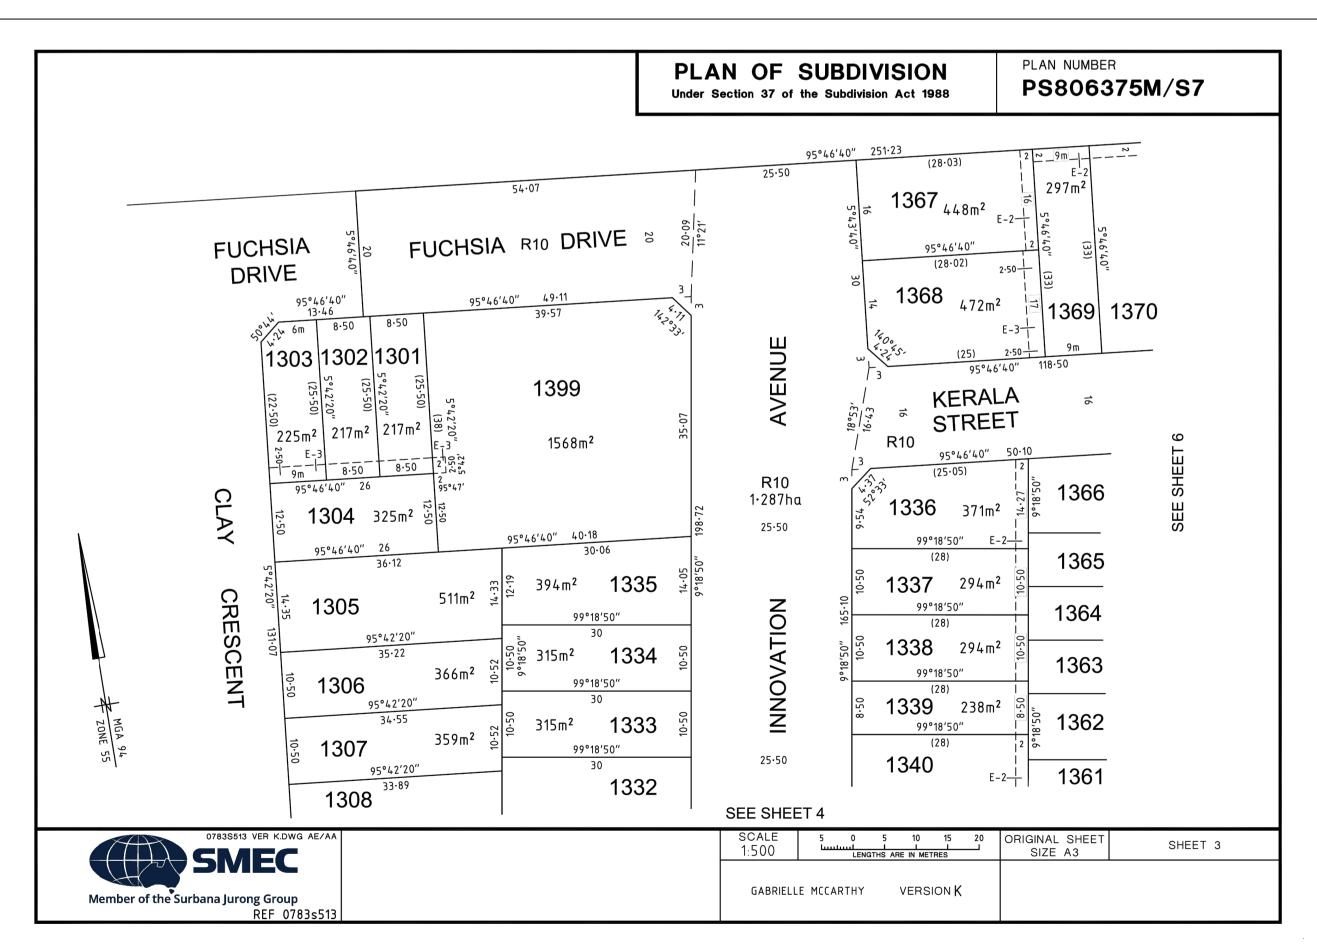

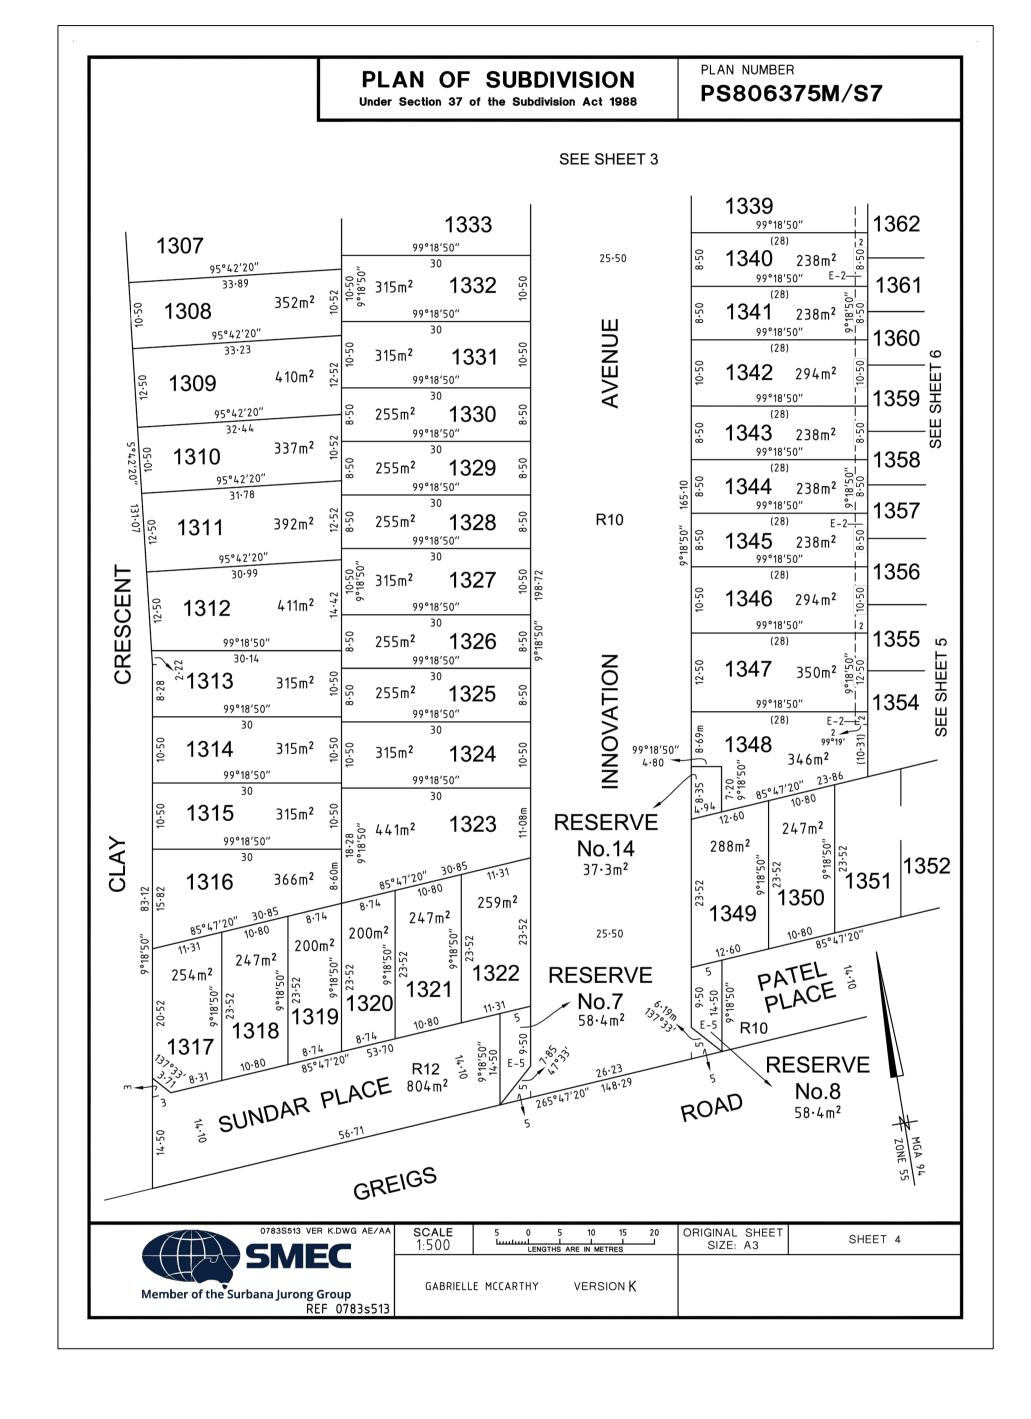

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D	AS CONSTRUCTED	21.06.23	JZ
С	POS AMENDED	04.02.22	JZ
В	CONSTRUCTION ISSUE	18.01.22	JZ
Α	PRELIMINARY ISSUE	23.03.2020	JZ
VERSION	REMARKS		


DRAWN BY	I N. NASHA		J. ZHOU	
MELWAY	344, K12	CHECKED BY	L. PHAN	
DATUM	AHD	AUTHORISED BY	S. RAVIDA	





CITY OF MELTON BRIDGEFIELD ESTATE, ROCKBANK STAGE 13 PLAN OF SUBDIVISION - 1

VERSION DRAWING No. 13R30 REFERENCE 22236E/13

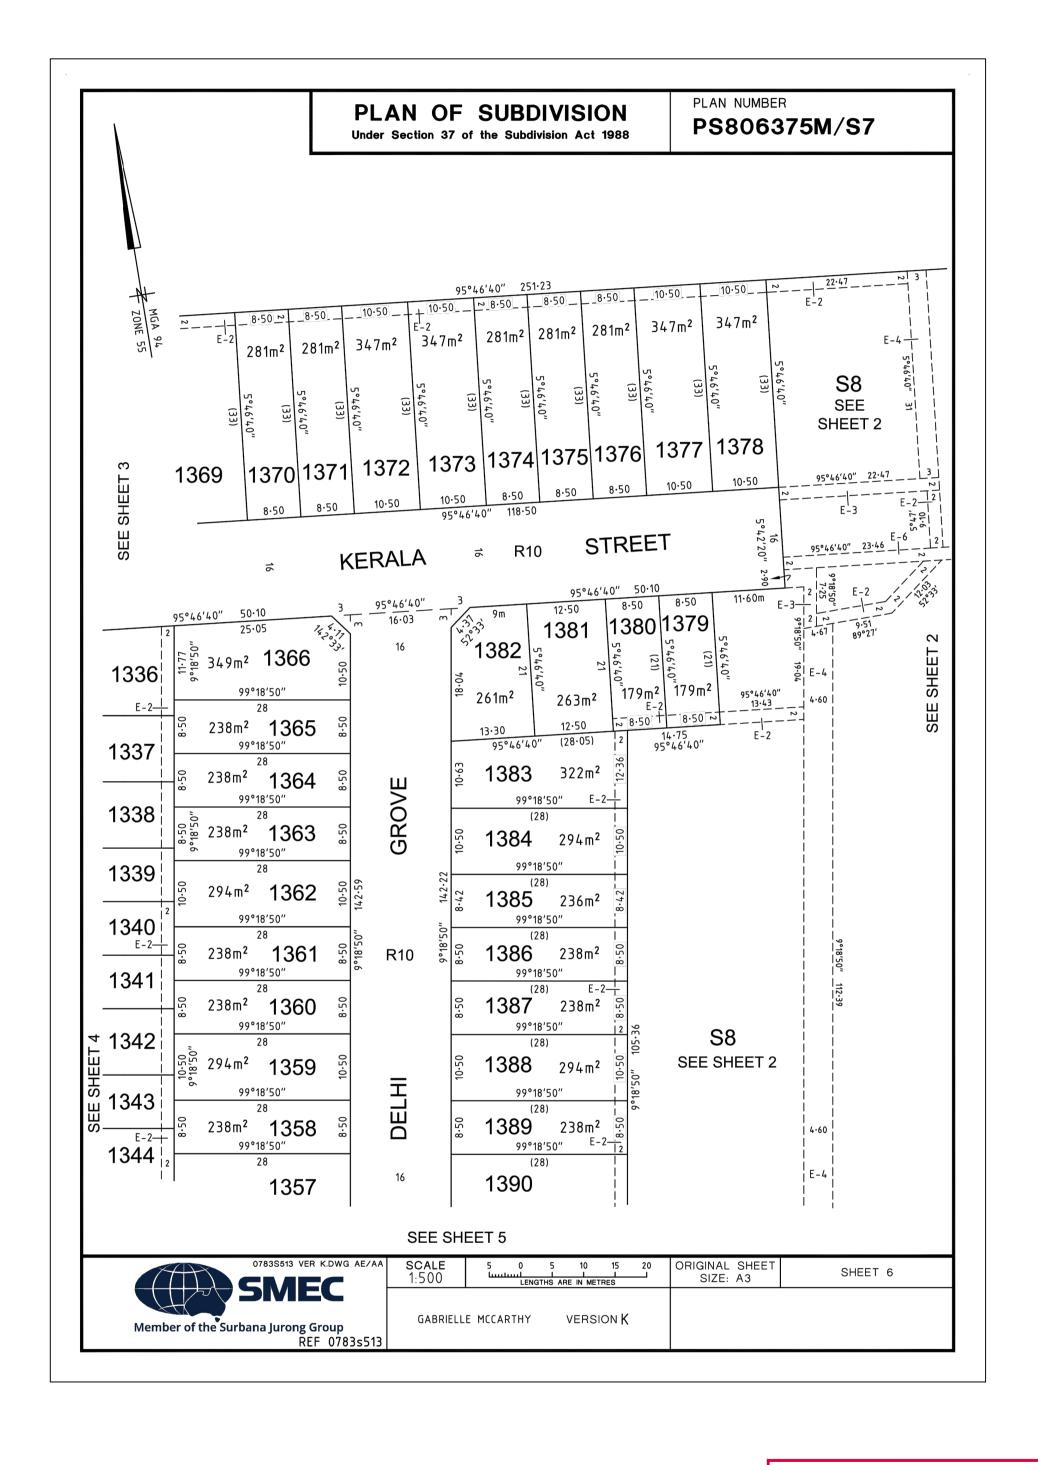

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13\CAD\	D	AS CONSTRUCTED	21.06.23	JZ
핑	С	POS AMENDED	04.02.22	JZ
:\22236\STA	В	CONSTRUCTION ISSUE	18.01.22	JZ
	Α	PRELIMINARY ISSUE	23.03.2020	JZ
	VERSION	REMARKS		

DRAWN BY	N. KASHA	DESIGNED BY	J. ZHOU	
MELWAY	344, K12	CHECKED BY	L. PHAN	
DATUM	AHD	AUTHORISED BY	S. RAVIDA	







CITY OF MELTON BRIDGEFIELD ESTATE, ROCKBANK STAGE 13 PLAN OF SUBDIVISION - 2

VERSION DRAWING No. 13R31 REFERENCE 22236E/13

PASSIVE STREET TREE IRRIGATION GRAVEL TRENCH (KERB INLET DIVERSION) DETAIL (ELEC / TESTRA SIDE) NOT TO SCALE

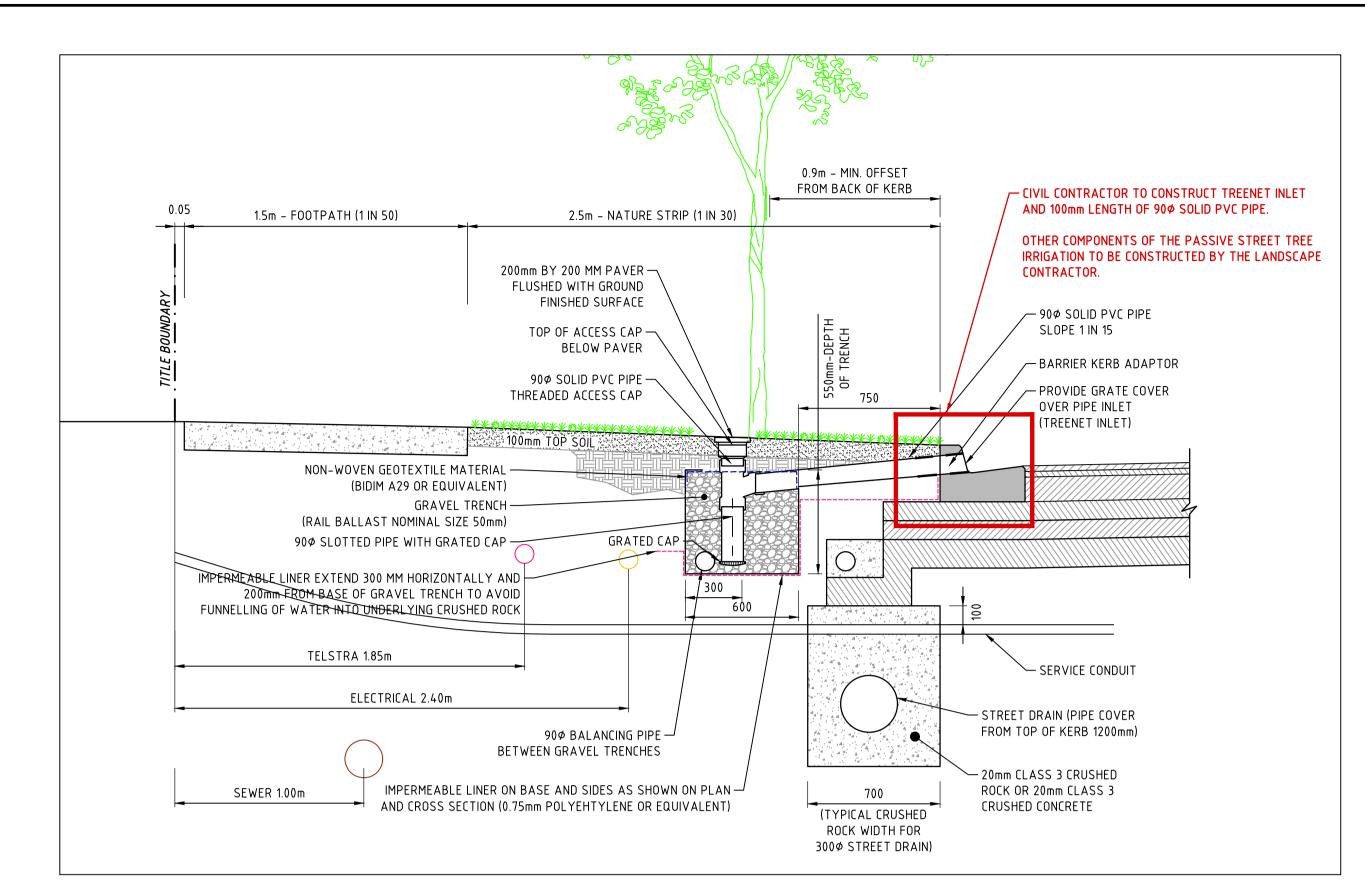


PASSIVE STREET TREE IRRIGATION GRAVEL TRENCH (KERB INLET DIVERSION) CROSS SECTION (ELEC / TELSTRA SIDE) SCALE 1:20

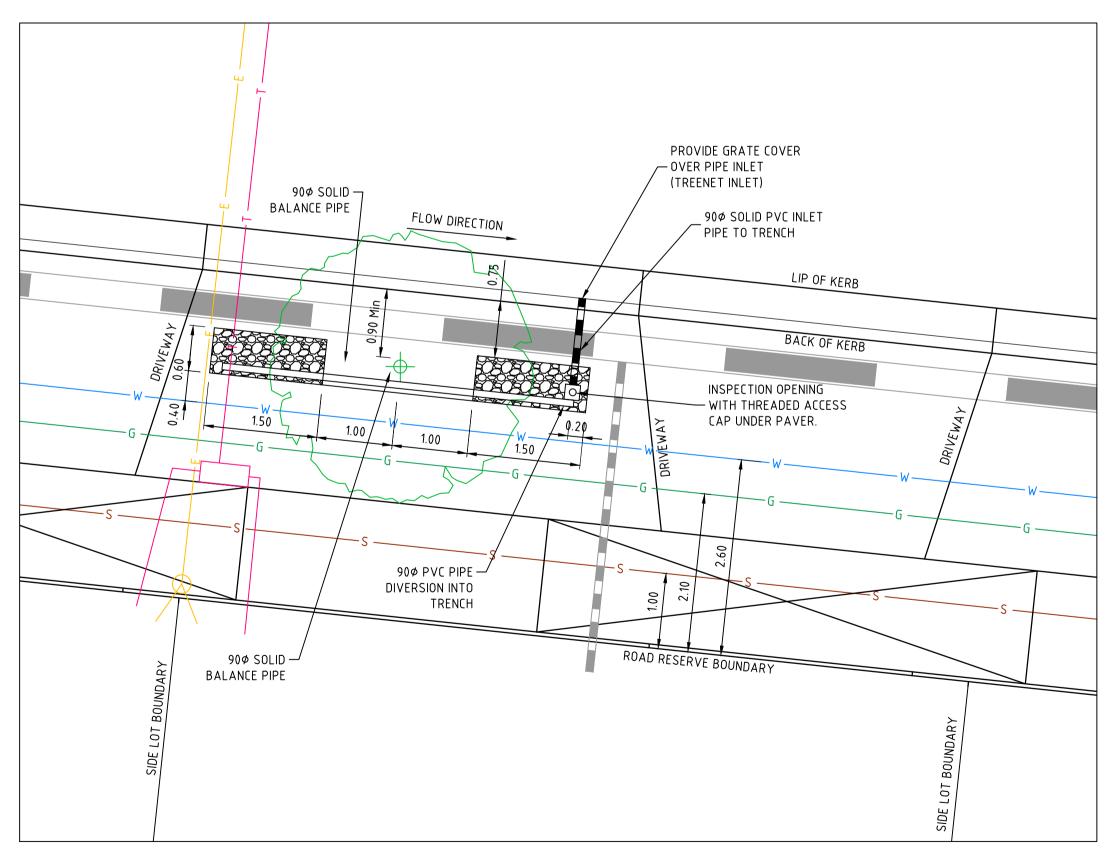



- EX TELSTRA SERVICES & PITS

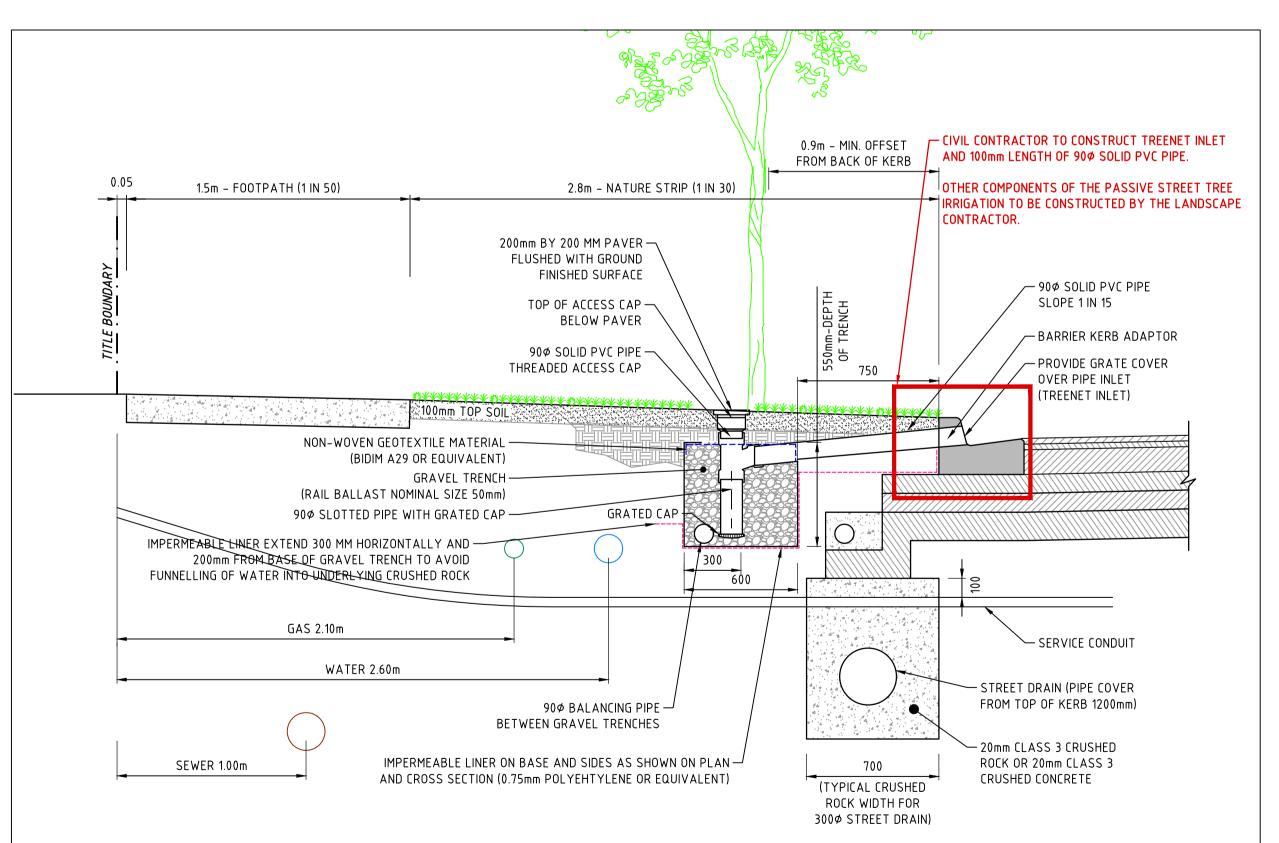

PASSIVE STREET TREE IRRIGATION GRAVEL TRENCH (KERB INLET DIVERSION) CROSS SECTION (GAS / WATER SIDE)

J. ZHOU

L. PHAN

S. RAVIDA

AT END OF SUBDIVISION CONSTRUCTION. THE PLAN IS NOT BASED ON SURVEY OF THE COMPLETED WORKS. ALL LEVELS, CO-ORDINATES AND SERVICE LOCATIONS SHOWN ON THE PLANS ARE THE DESIGN INFORMATION AND SHOULD NOT BE RELIED UPON BY ANY FUTURE PARTY IN RELATION TO DETAILED DESIGN ACTIVITIES. THESE PLANS ARE PROVIDED TO COUNCIL FOR ASSET MANAGEMENT PURPOSES AND ANY USE OF THE PLANS BY THIRD PARTIES IS NOT PERMITTED. ANY SUBSEQUENT DESIGN OR CONSTRUCTION ACTIVITIES IN THE AREA DEFINED ON THESE PLANS WILL REQUIRE ADDITIONAL SITE SURVEY AND **ASSET PROVING BY THE RELEVANT PARTY.**

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REMARKS

VERSION

2					DRAIN, PROPERTY INLET & PIT	LEGEND
3\CAD	D	AS CONSTRUCTED	21.06.23	JZ	HOUSE DRAIN	
GE 13	С	IMPERMEABLE LINER ADDED	30.03.22	JZ	S SEWER AND MAINTENANCE HOLE EXS - EX SEWER AND MAINTENANCE HOLE	ELECTRICAL U.G. SERVICES EXEL—EXELECTRICAL U.G. SERVICES
\STA	В	CONSTRUCTION ISSUE	18.01.22	JZ	WATER MAIN EX WATER MAIN, VALVE & HYDRANT	E ELECTRICAL SERVICE & PIT LIGHT POLE PIT EX ELECTRICAL ASSETS EX ELECTRICAL ASSETS
2236	Α	PRELIMINARY ISSUE	23.03.2020	JZ	G——— GAS MAIN ————————————————————————————————————	GAS & WATER CONDUITS


F Fb P	FINISHED SURFACE AFTER CU TOP OF PROPOSED BATTER PROPOSED PAVEMENT OR FO		DRAWN BY	N. KASHA	DESIGNED BY	
•						П
IL	IL EXISTING OR PROPOSED INVERT LEVEL OF PIPE OR OPEN DRAIN		MELWAY	344, K12	CHECKED	
TP	TANGENT POINT →	STREET SIGN	I ILL WAT	3 ,	BY	
CH	CHAINAGE (2)	DRAINAGE PIT No.				
^	PSM 1	TBM			AUTHORISED	
	/ EX FENCE			AHD	BY	

C O N S U L T I	N G	LAND SURVEYING CIVIL ENGINEERING PLANNING DEVELOPMENT CONSULTING
www.reedsconsulting.com.au engineering@reedsconsulting.com.au	Lvl 16, 501 Swanston p (03) 8660 3000	Street Melbourne Victoria 3000 Copyright © Reeds Consulting Pty Ltd All Rights Reserved 2001

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/IL ENGINEERING	0.45
ANNING	4500, certifie
VELOPMENT CONSULTING	NSO 1400
Melbourne Victoria 3000	certified

CITY OF MELTON BRIDGEFIELD ESTATE, ROCKBANK STAGE 13 GRAVEL TRENCH (KERB INLET DIVERSION DETAILS)

ORAWING No.	VERSION				
13R32	D				
REFERENCE					
22236E/13					

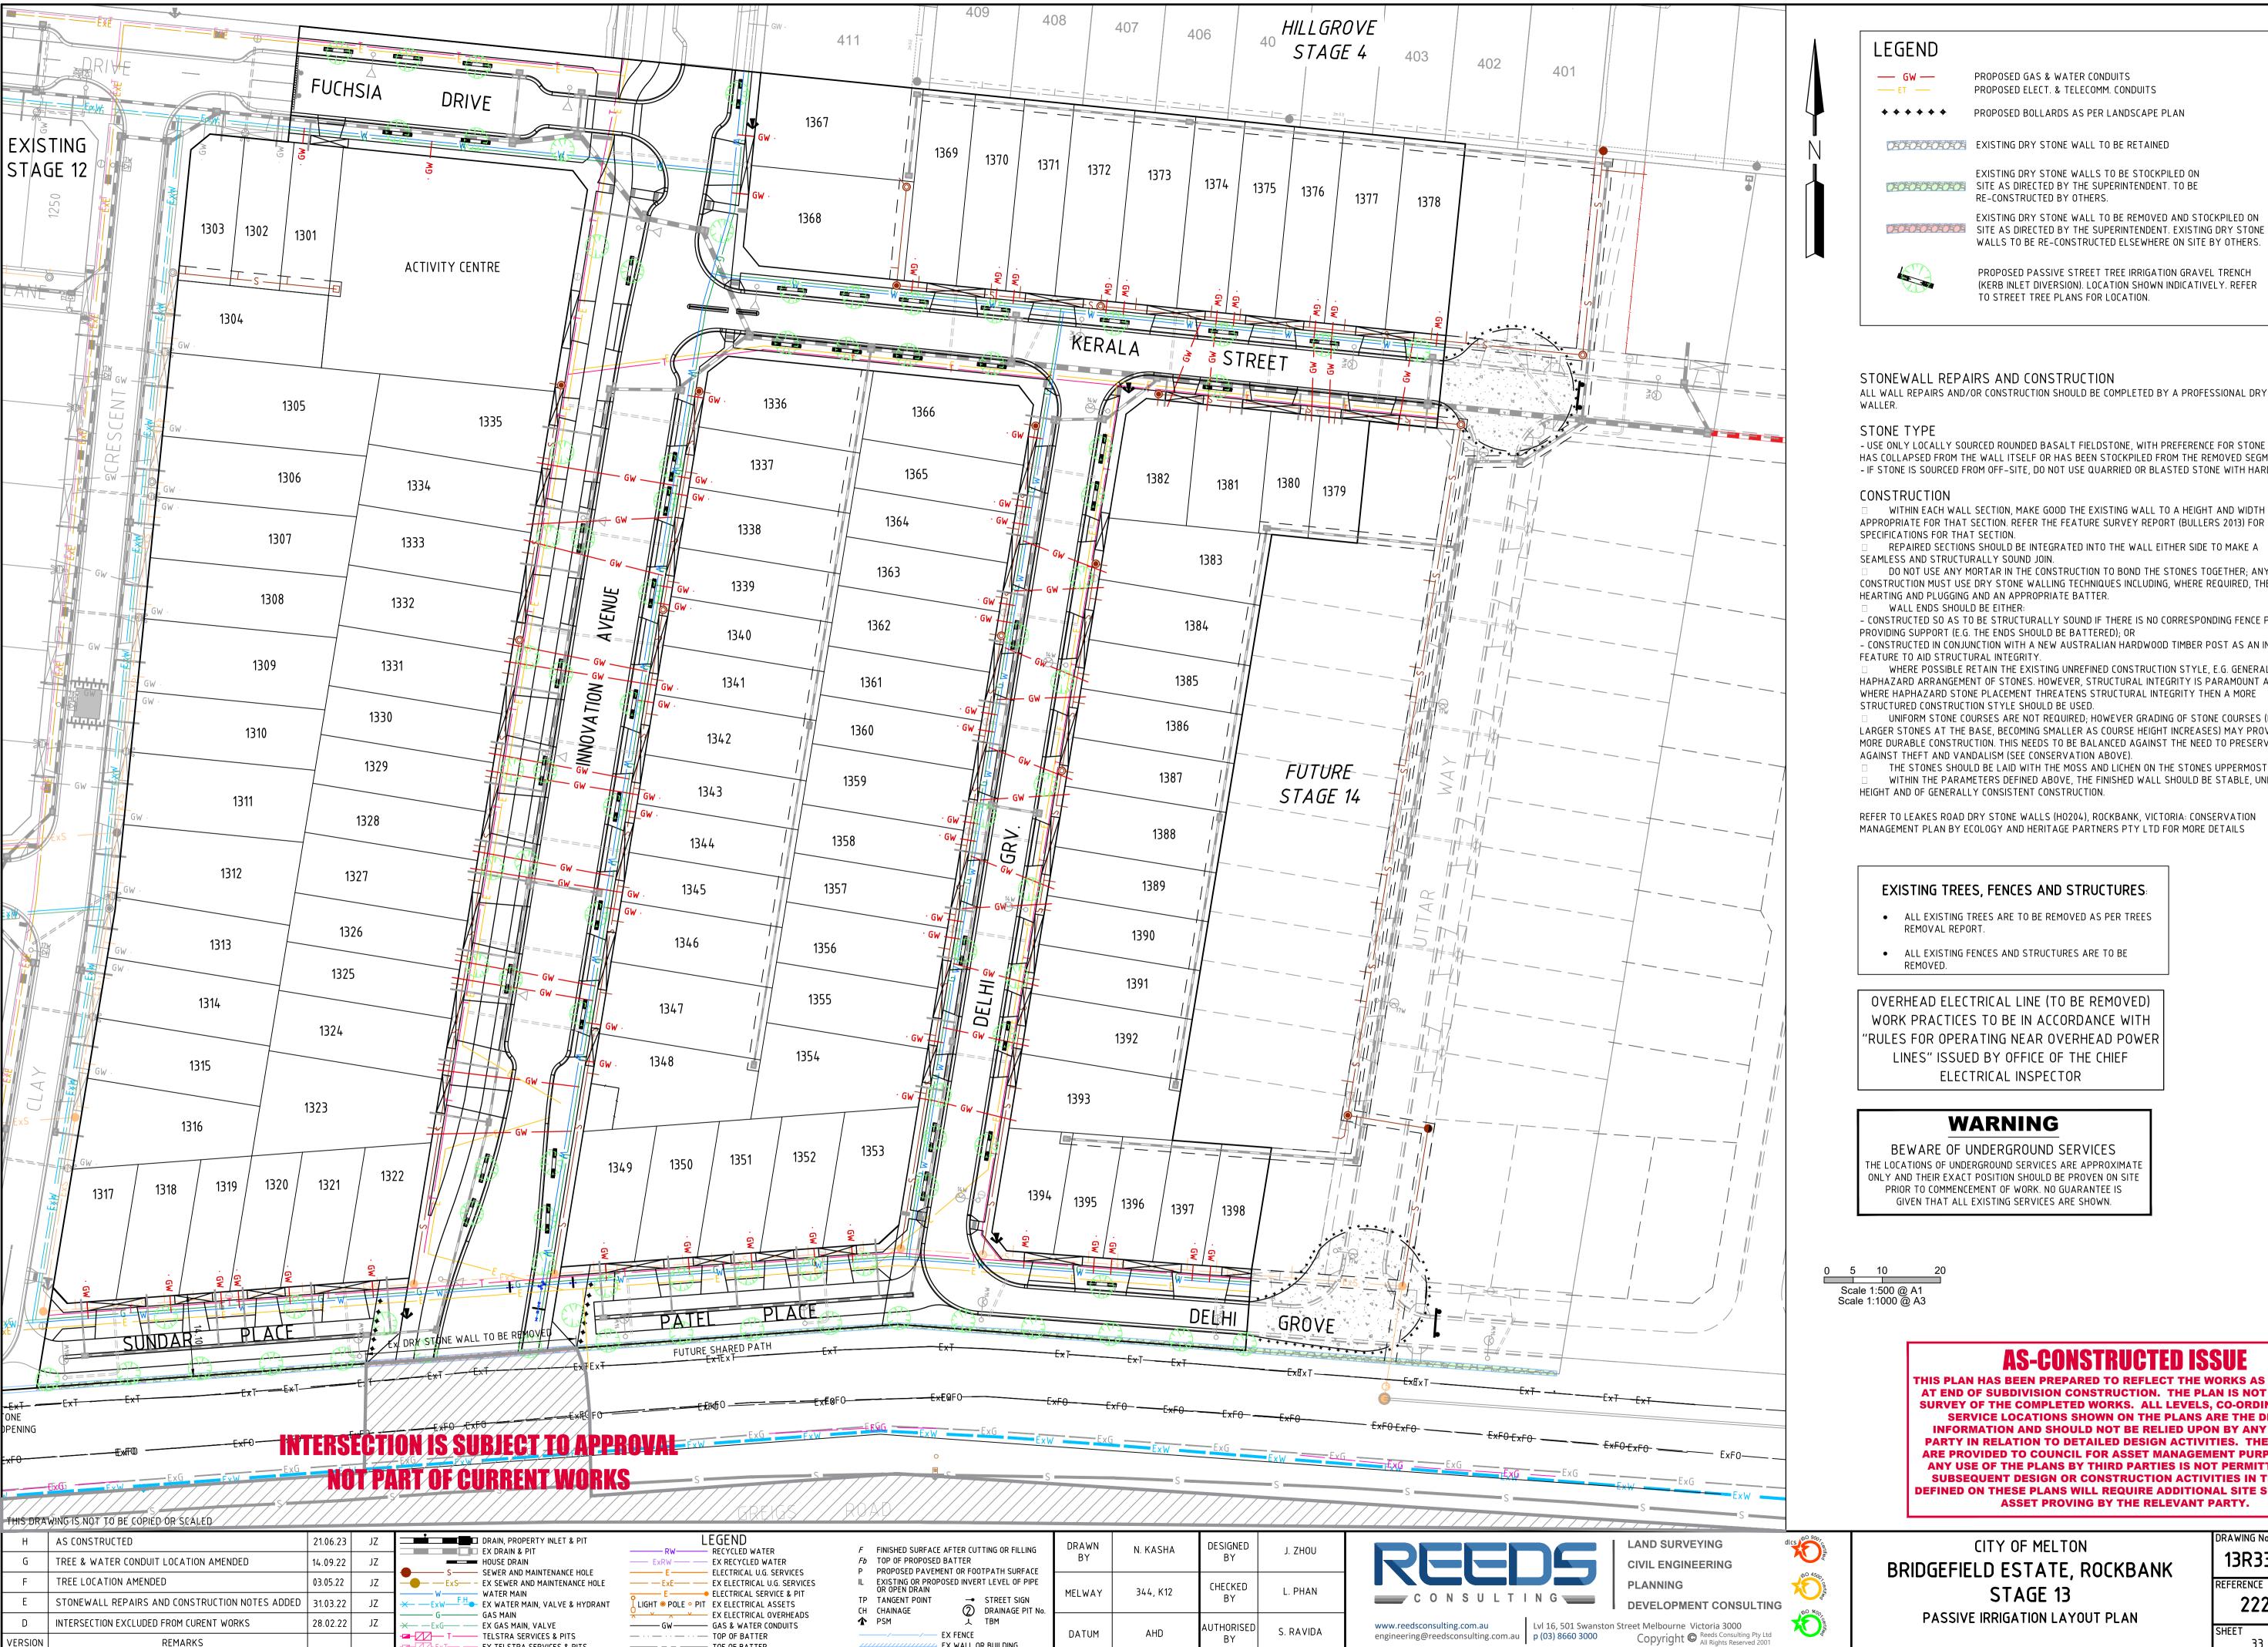

S. RAVIDA

AHD

DATUM

EX FENCE

EX WALL OR BUILDING

— · · — · · — TOP OF BATTER

——————— TOE OF BATTER

TELSTRA SERVICES & PITS

- EX TELSTRA SERVICES & PITS

REMARKS

LEGEND

PROPOSED GAS & WATER CONDUITS PROPOSED ELECT. & TELECOMM. CONDUITS

◆ ◆ ◆ ◆ ◆ PROPOSED BOLLARDS AS PER LANDSCAPE PLAN

EXISTING DRY STONE WALL TO BE RETAINED

EXISTING DRY STONE WALLS TO BE STOCKPILED ON

SITE AS DIRECTED BY THE SUPERINTENDENT. TO BE RE-CONSTRUCTED BY OTHERS. EXISTING DRY STONE WALL TO BE REMOVED AND STOCKPILED ON



PROPOSED PASSIVE STREET TREE IRRIGATION GRAVEL TRENCH (KERB INLET DIVERSION). LOCATION SHOWN INDICATIVELY. REFER TO STREET TREE PLANS FOR LOCATION.

WALLS TO BE RE-CONSTRUCTED ELSEWHERE ON SITE BY OTHERS.

STONEWALL REPAIRS AND CONSTRUCTION

ALL WALL REPAIRS AND/OR CONSTRUCTION SHOULD BE COMPLETED BY A PROFESSIONAL DRY STONE

STONE TYPE

- USE ONLY LOCALLY SOURCED ROUNDED BASALT FIELDSTONE, WITH PREFERENCE FOR STONE THAT HAS COLLAPSED FROM THE WALL ITSELF OR HAS BEEN STOCKPILED FROM THE REMOVED SEGMENT. - IF STONE IS SOURCED FROM OFF-SITE, DO NOT USE QUARRIED OR BLASTED STONE WITH HARD EDGES

WITHIN EACH WALL SECTION, MAKE GOOD THE EXISTING WALL TO A HEIGHT AND WIDTH APPROPRIATE FOR THAT SECTION. REFER THE FEATURE SURVEY REPORT (BULLERS 2013) FOR TYPICAL SPECIFICATIONS FOR THAT SECTION.

REPAIRED SECTIONS SHOULD BE INTEGRATED INTO THE WALL EITHER SIDE TO MAKE A SEAMLESS AND STRUCTURALLY SOUND JOIN.

DO NOT USE ANY MORTAR IN THE CONSTRUCTION TO BOND THE STONES TOGETHER; ANY CONSTRUCTION MUST USE DRY STONE WALLING TECHNIQUES INCLUDING, WHERE REQUIRED, THE USE OF HEARTING AND PLUGGING AND AN APPROPRIATE BATTER.

WALL ENDS SHOULD BE EITHER: - CONSTRUCTED SO AS TO BE STRUCTURALLY SOUND IF THERE IS NO CORRESPONDING FENCE POST

PROVIDING SUPPORT (E.G. THE ENDS SHOULD BE BATTERED); OR

- CONSTRUCTED IN CONJUNCTION WITH A NEW AUSTRALIAN HARDWOOD TIMBER POST AS AN INTEGRAL FEATURE TO AID STRUCTURAL INTEGRITY

WHERE POSSIBLE RETAIN THE EXISTING UNREFINED CONSTRUCTION STYLE, E.G. GENERALLY HAPHAZARD ARRANGEMENT OF STONES. HOWEVER, STRUCTURAL INTEGRITY IS PARAMOUNT AND, WHERE HAPHAZARD STONE PLACEMENT THREATENS STRUCTURAL INTEGRITY THEN A MORE STRUCTURED CONSTRUCTION STYLE SHOULD BE USED.

UNIFORM STONE COURSES ARE NOT REQUIRED; HOWEVER GRADING OF STONE COURSES (I.E. LARGER STONES AT THE BASE, BECOMING SMALLER AS COURSE HEIGHT INCREASES) MAY PROVIDE A MORE DURABLE CONSTRUCTION. THIS NEEDS TO BE BALANCED AGAINST THE NEED TO PRESERVE AGAINST THEFT AND VANDALISM (SEE CONSERVATION ABOVE).

THE STONES SHOULD BE LAID WITH THE MOSS AND LICHEN ON THE STONES UPPERMOST. WITHIN THE PARAMETERS DEFINED ABOVE, THE FINISHED WALL SHOULD BE STABLE, UNIFORM IN HEIGHT AND OF GENERALLY CONSISTENT CONSTRUCTION.

REFER TO LEAKES ROAD DRY STONE WALLS (HO204), ROCKBANK, VICTORIA: CONSERVATION MANAGEMENT PLAN BY ECOLOGY AND HERITAGE PARTNERS PTY LTD FOR MORE DETAILS

EXISTING TREES, FENCES AND STRUCTURES:

- ALL EXISTING TREES ARE TO BE REMOVED AS PER TREES REMOVAL REPORT.
- ALL EXISTING FENCES AND STRUCTURES ARE TO BE

OVERHEAD ELECTRICAL LINE (TO BE REMOVED) WORK PRACTICES TO BE IN ACCORDANCE WITH

LINES" ISSUED BY OFFICE OF THE CHIEF ELECTRICAL INSPECTOR

WARNING

BEWARE OF UNDERGROUND SERVICES THE LOCATIONS OF UNDERGROUND SERVICES ARE APPROXIMATI ONLY AND THEIR EXACT POSITION SHOULD BE PROVEN ON SITE PRIOR TO COMMENCEMENT OF WORK. NO GUARANTEE IS GIVEN THAT ALL EXISTING SERVICES ARE SHOWN.

Scale 1:500 @ A1 Scale 1:1000 @ A3

AS-CONSTRUCTED ISSUE


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CITY OF MELTON

BRIDGEFIELD ESTATE, ROCKBANK STAGE 13 PASSIVE IRRIGATION LAYOUT PLAN

VERSION DRAWING No. 13R33 REFERENCE

22236E/13

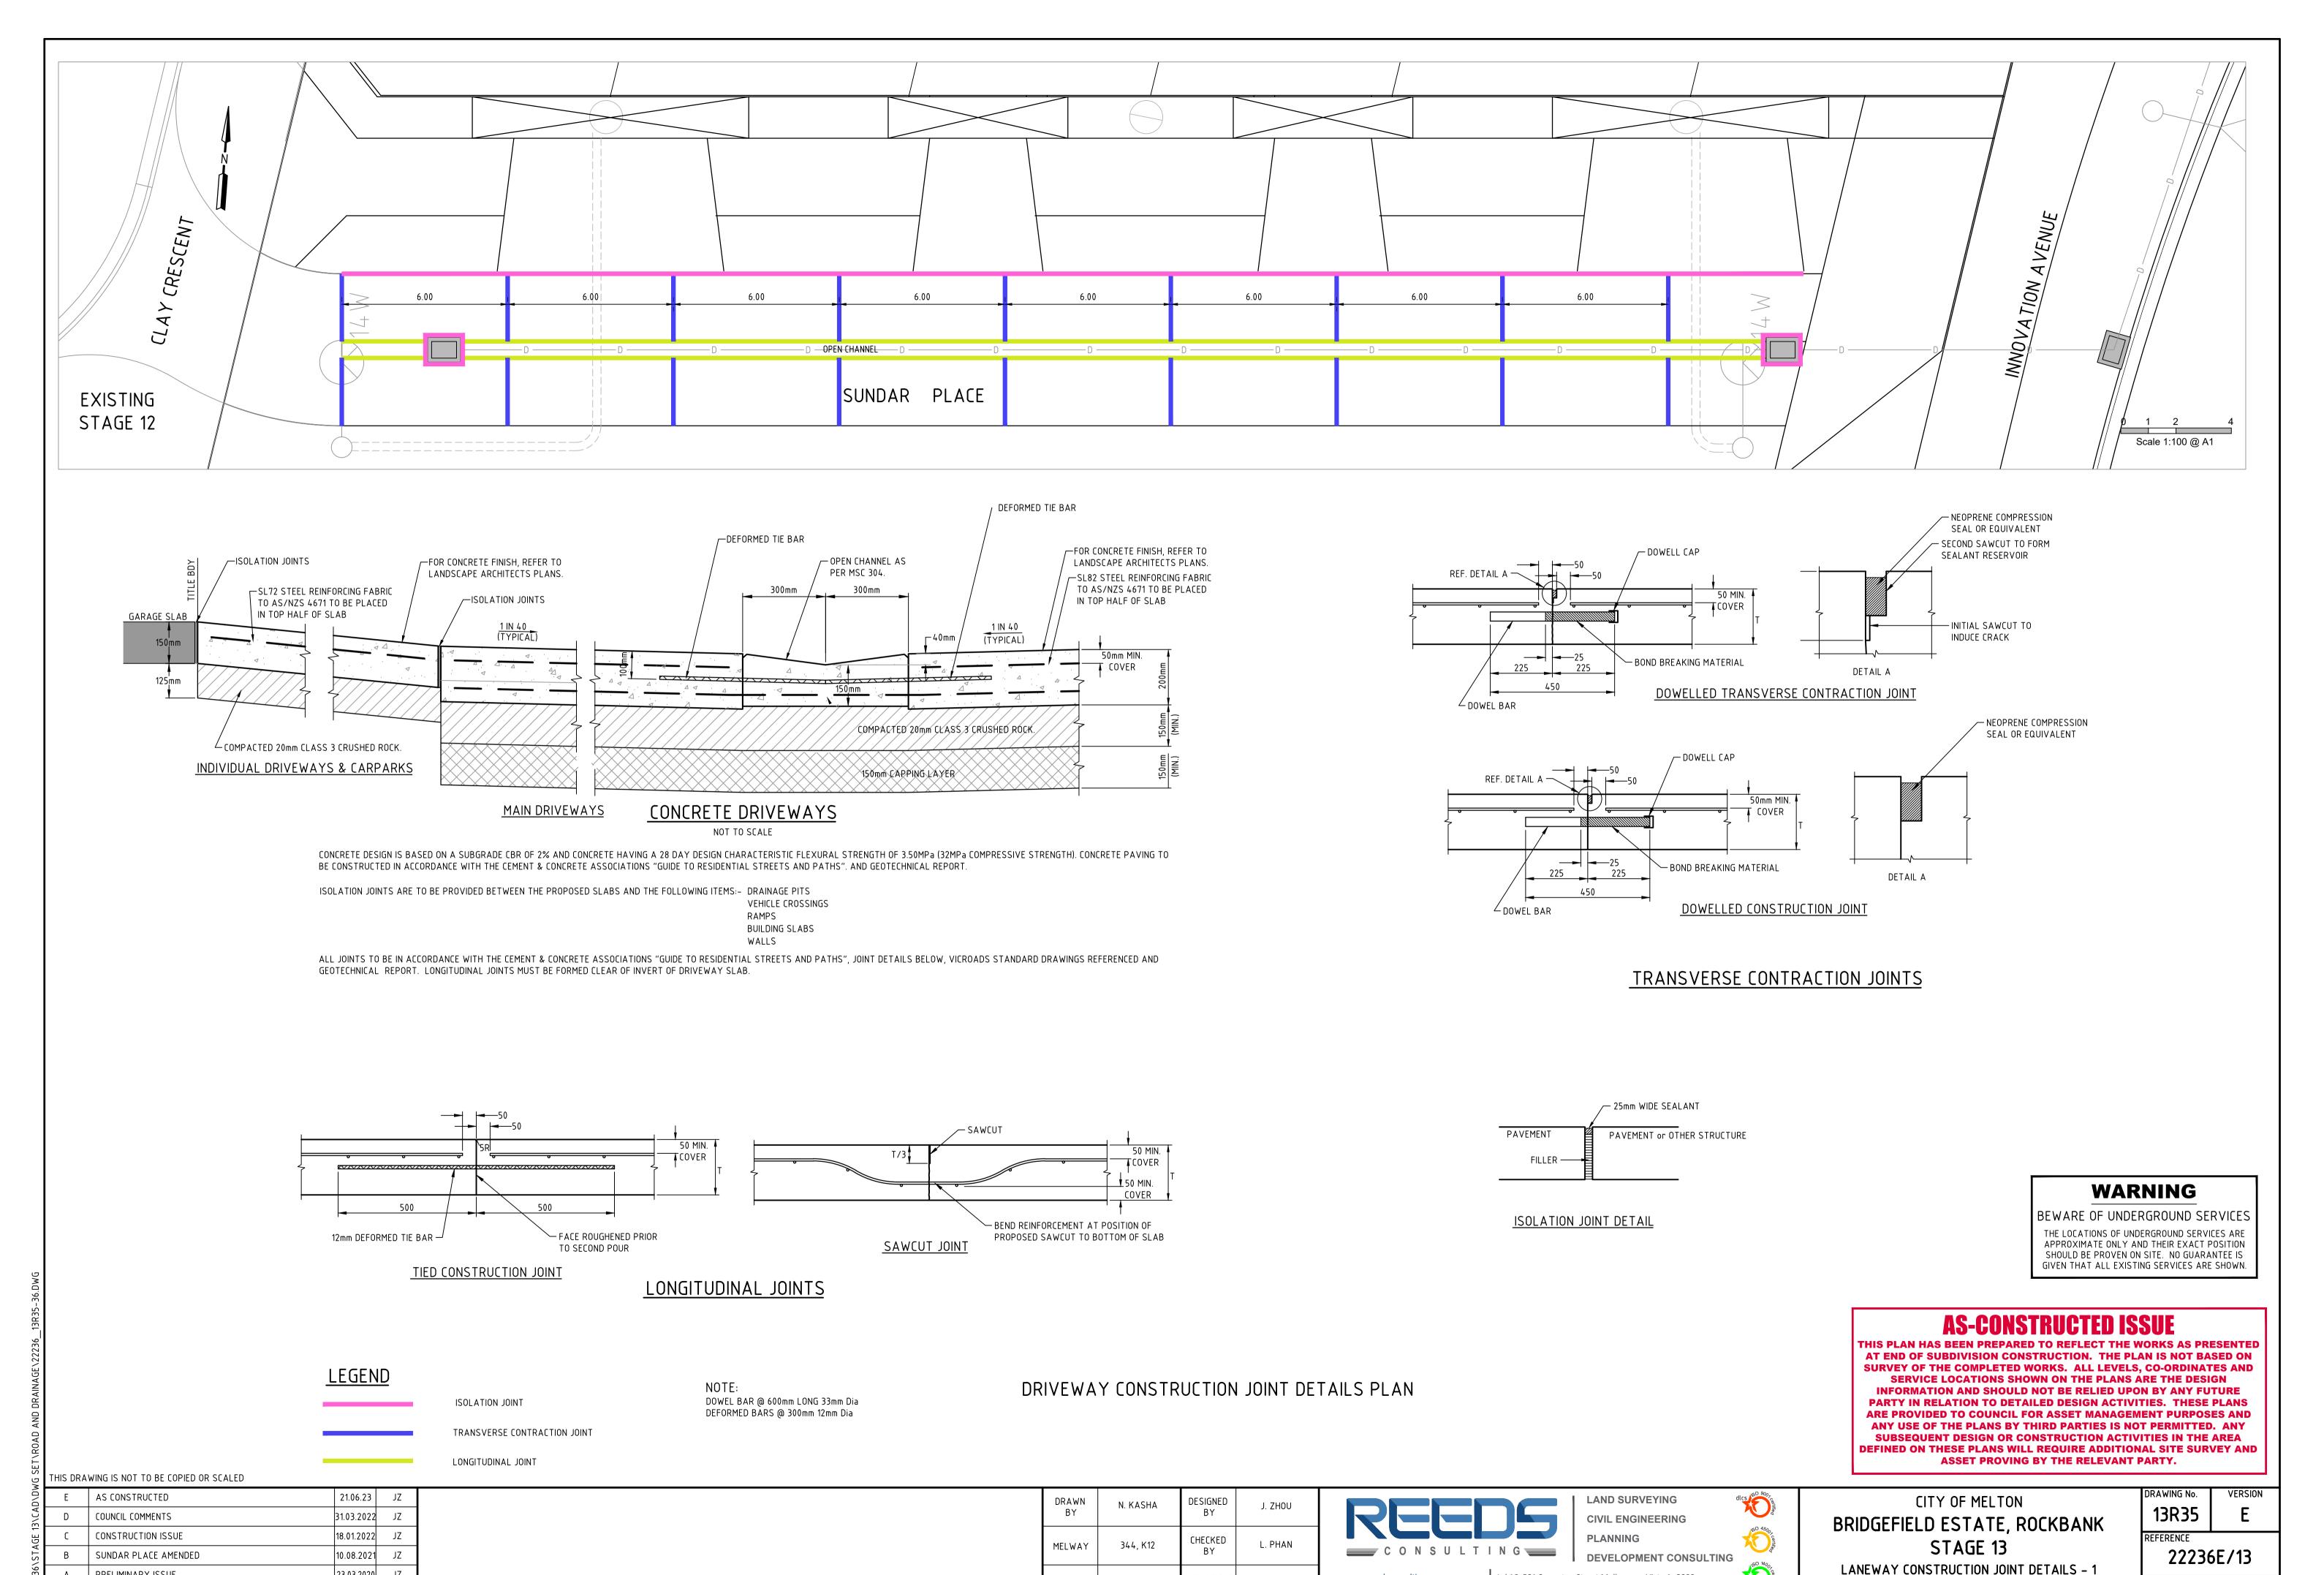

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DATUM

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S. RAVIDA

PRELIMINARY ISSUE


VERSION

REMARKS

23.03.2020 JZ

35 OF 36

UNCLE LANE, AUNTY LANE & SHARMA LANE

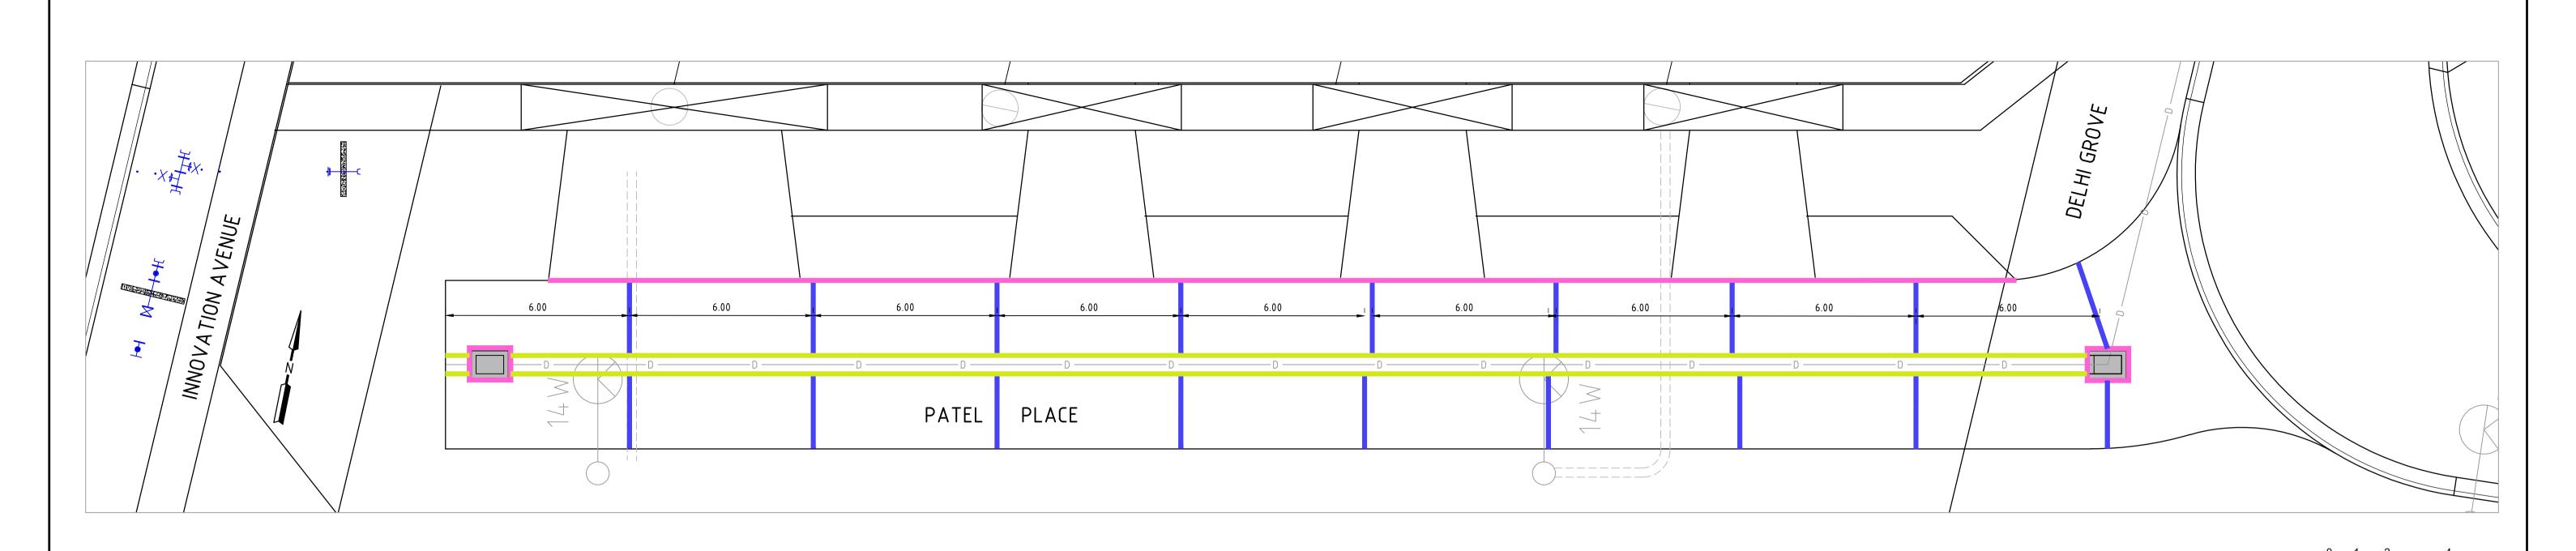

WARNING

BEWARE OF UNDERGROUND SERVICES

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13\CAD\D\	D	AS CONSTRUCTED	21.06.23	JZ
넁	С	CONSTRUCTION ISSUE	18.01.2022	JZ
STA	В	PATEL PLACE AMENDED	10.08.2021	JZ
H:\22236\	А	PRELIMINARY ISSUE	23.03.2020	JZ
H:\2;	VERSION	REMARKS		

DRAWN BY	N. KASHA	DESIGNED BY	J. ZHOU	
MELWAY	344, K12	CHECKED BY	L. PHAN	
DATUM	AHD	AUTHORISED BY	S. RAVIDA	



LAND SURVEYING **CIVIL ENGINEERING DEVELOPMENT CONSULTING**

CITY OF MELTON BRIDGEFIELD ESTATE, ROCKBANK STAGE 13 LANEWAY CONSTRUCTION JOINT DETAILS - 2

KUMAR LANE

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	REFERENCE				
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